HISTORIC AND DESIGN REVIEW COMMISSION December 07, 2022

HDRC CASE NO: 2022-560

ADDRESS: 227 W GRAMERCY

LEGAL DESCRIPTION: NCB 3970 BLK D LOT 29

ZONING: R-5, H CITY COUNCIL DIST.:

HIST. DIST. NAME: Monte Vista

APPLICANT: Darian Mason/Peli and Mason Architecture Shop

OWNER: Aaron Prado/ PRADO AARON ELLINGTON & LOREN ELAINE

TYPE OF WORK: Partial demolition (primary and accessory), construction of two-story additions

(primary and accessory)

APPLICATION RECEIVED: June 6, 2022

60-DAY REVIEW: Not applicable due to City Council Emergency Orders

CASE MANAGER: Jessica Anderson

REQUEST:

The applicant requests a Certificate of Appropriateness for approval to:

- 1. Demolish a small addition on the rear of the primary structure.
- 2. Construct a two-story addition to the rear of the primary structure.
- 3. Demolish an addition and carport on the garage.
- 4. Construct a two-story addition to the garage.
- 5. Add bike and utility enclosures to the west side of the backyard.
- 6. Add a pervious terrace to the west side of the backyard.
- 7. Add landscaping.

APPLICABLE CITATIONS:

Historic Design Guidelines, Chapter 2, Exterior Maintenance and Alterations

7. Architectural Features: Porches, Balconies, and Porte-Cocheres

A. MAINTENANCE (PRESERVATION)

- i. *Existing porches, balconies, and porte-cocheres*—Preserve porches, balconies, and porte-cocheres. Do not add new porches, balconies, or porte-cocheres where not historically present.
- ii. *Balusters*—Preserve existing balusters. When replacement is necessary, replace in-kind when possible or with balusters that match the originals in terms of materials, spacing, profile, dimension, finish, and height of the railing.
- iii. *Floors*—Preserve original wood or concrete porch floors. Do not cover original porch floors of wood or concrete with carpet, tile, or other materials unless they were used historically.

B. ALTERATIONS (REHABILITATION, RESTORATION, AND RECONSTRUCTION)

- i. *Front porches*—Refrain from enclosing front porches. Approved screen panels should be simple in design as to not change the character of the structure or the historic fabric.
- ii. Side and rear porches—Refrain from enclosing side and rear porches, particularly when connected to the main porch or balcony. Original architectural details should not be obscured by any screening or enclosure materials. Alterations to side and rear porches should result in a space that functions, and is visually interpreted as, a porch.
- iii. Replacement—Replace in-kind porches, balconies, porte-cocheres, and related elements, such as ceilings, floors, and columns, when such features are deteriorated beyond repair. When in-kind replacement is not feasible, the design should be compatible in scale, massing, and detail while materials should match in color, texture, dimensions, and finish.
- iv. *Adding elements*—Design replacement elements, such as stairs, to be simple so as to not distract from the historic character of the building. Do not add new elements and details that create a false historic appearance.
- v. *Reconstruction*—Reconstruct porches, balconies, and porte-cocheres based on accurate evidence of the original, such as photographs. If no such evidence exists, the design should be based on the architectural style of the building and historic patterns.

9. Outbuildings, Including Garages

A. MAINTENANCE (PRESERVATION)

- i. Existing outbuildings—Preserve existing historic outbuildings where they remain.
- ii. *Materials*—Repair outbuildings and their distinctive features in-kind. When new materials are needed, they should match existing materials in color, durability, and texture. Refer to maintenance and alteration of applicable materials above, for additional guidelines.

B. ALTERATIONS (REHABILITATION, RESTORATION, AND RECONSTRUCTION)

- i. *Garage doors*—Ensure that replacement garage doors are compatible with those found on historic garages in the district (e.g., wood paneled) as well as with the principal structure. When not visible from the public right-of-way, modern paneled garage doors may be acceptable.
- ii. *Replacement*—Replace historic outbuildings only if they are beyond repair. In-kind replacement is preferred; however, when it is not possible, ensure that they are reconstructed in the same location using similar scale, proportion, color, and materials as the original historic structure.
- iii. Reconstruction—Reconstruct outbuildings based on accurate evidence of the original, such as photographs. If no such evidence exists, the design should be based on the architectural style of the primary building and historic patterns in the district. Add permanent foundations to existing outbuildings where foundations did not historically exist only as a last resort.

Historic Design Guidelines, Chapter 3, Guidelines for Additions

1. Massing and Form of Residential Additions

A. GENERAL

- i. *Minimize visual impact*—Site residential additions at the side or rear of the building whenever possible to minimize views of the addition from the public right-of-way. An addition to the front of a building would be inappropriate.
- ii. *Historic context*—Design new residential additions to be in keeping with the existing, historic context of the block. For example, a large, two-story addition on a block comprised of single-story homes would not be appropriate.
- iii. Similar roof form—Utilize a similar roof pitch, form, overhang, and orientation as the historic structure for additions.
- iv. *Transitions between old and new*—Utilize a setback or recessed area and a small change in detailing at the seam of the historic structure and new addition to provide a clear visual distinction between old and new building forms.

B. SCALE, MASSING, AND FORM

- i. Subordinate to principal facade—Design residential additions, including porches and balconies, to be subordinate to the principal façade of the original structure in terms of their scale and mass.
- ii. *Rooftop additions*—Limit rooftop additions to rear facades to preserve the historic scale and form of the building from the street level and minimize visibility from the public right-of-way. Full-floor second story additions that obscure the form of the original structure are not appropriate.
- iii. *Dormers*—Ensure dormers are compatible in size, scale, proportion, placement, and detail with the style if the house. Locate dormers only on non-primary facades (those not facing the public right-of-way) if not historically found within the district.
- iv. Footprint—The building footprint should respond to the size of the lot. An appropriate yard to building ratio should be maintained for consistency within historic districts. Residential additions should not be so large as to double the existing building footprint, regardless of lot size.
- v. *Height*—Generally, the height of new additions should be consistent with the height of the existing structure. The maximum height of new additions should be determined by examining the line-of-sight or visibility from the street. Addition height should never be so contrasting as to overwhelm or distract from the existing structure.

3. Materials and Textures

A. COMPLEMENTARY MATERIALS

- i. *Complementary materials*—Use materials that match in type, color, and texture and include an offset or reveal to distinguish the addition from the historic structure whenever possible. Any new materials introduced to the site as a result of an addition must be compatible with the architectural style and materials of the original structure.
- ii. *Metal roofs*—Construct new metal roofs in a similar fashion as historic metal roofs. Refer to the Guidelines for Alternations and Maintenance section for additional specifications regarding metal roofs.

iii. *Other roofing materials*—Match original roofs in terms of form and materials. For example, when adding on to a building with a clay tile roof, the addition should have a roof that is clay tile, synthetic clay tile, or a material that appears similar in color and dimension to the existing clay tile.

B. INAPPROPRIATE MATERIALS

i. *Imitation or synthetic materials*—Do not use imitation or synthetic materials, such as vinyl siding, brick or simulated stone veneer, plastic, or other materials not compatible with the architectural style and materials of the original structure.

C. REUSE OF HISTORIC MATERIALS

ii. Salvage—Salvage and reuse historic materials, where possible, that will be covered or removed as a result of an addition

4. Architectural Details

A. GENERAL

- i. *Historic context*—Design additions to reflect their time while respecting the historic context. Consider character-defining features and details of the original structure in the design of additions. These architectural details include roof form, porches, porticos, cornices, lintels, arches, quoins, chimneys, projecting bays, and the shapes of window and door openings.
- ii. Architectural details—Incorporate architectural details that are in keeping with the architectural style of the original structure. Details should be simple in design and compliment the character of the original structure. Architectural details that are more ornate or elaborate than those found on the original structure should not be used to avoid drawing undue attention to the addition.
- iii. *Contemporary interpretations*—Consider integrating contemporary interpretations of traditional designs and details for additions. Use of contemporary window moldings and door surroundings, for example, can provide visual interest while helping to convey the fact that the addition is new.

Standard Specifications for Windows in Additions and New Construction

- GENERAL: New windows on additions should relate to the windows of the primary historic structure in terms of materiality and overall appearance. Windows used in new construction should be similar in appearance to those commonly found within the district in terms of size, profile, and configuration. While no material is expressly prohibited by the Historic Design Guidelines, a high-quality wood or aluminum-clad wood window product often meets the Guidelines with the stipulations listed below. Whole window systems should match the size of historic windows on property unless otherwise approved.
- SIZE: Windows should feature traditional dimensions and proportions as found within the district.
- SASH: Meeting rails must be no taller than 1.25". Stiles must be no wider than 2.25". Top and bottom sashes must be equal in size unless otherwise approved.
- DEPTH: There should be a minimum of 2" in depth between the front face of the window trim and the front face of the top window sash.
 - This must be accomplished by recessing the window sufficiently within the opening or with the installation of additional window trim to add thickness.
- TRIM: Window trim must feature traditional dimensions and architecturally appropriate casing and sloped sill detail. Window track components such as jamb liners must be painted to match the window trim or concealed by a wood window screen set within the opening.
- GLAZING: Windows should feature clear glass. Low-e or reflective coatings are not recommended for replacements. The glazing should not feature faux divided lights with an interior grille. If approved to match a historic window configuration, the window should feature real exterior muntins.
- COLOR: Wood windows should feature a painted finished. If a clad product is approved, white or metallic manufacturer's color is not allowed, and color selection must be presented to staff.
- INSTALLATION: Wood windows should be supplied in a block frame and exclude nailing fins. Window opening sizes should not be altered to accommodate stock sizes prior to approval.
- FINAL APPROVAL: If the proposed window does not meet the aforementioned stipulations, then the applicant must submit updated window specifications to staff for review, prior to purchase and installation. For more assistance, the applicant may request the window supplier to coordinate with staff directly for verification.

FINDINGS:

a. The property at 277 W Gramercy is a two-story Neoclassical residence with detached garage built c. 1927. The address first appears in the 1927-28 San Antonio city directory. The house, which sits on the corner of W

Gramercy Pl and Belknap Pl, is clad in brick with one-over-one wood windows and a composition shingle gable-on-hip roof. The porch features double-height columns and a centered entrance. The brick-clad garage has a hipped composition shingle roof, and the divided double bay opens west onto Belknap Pl. The double-wide full-width driveway is covered by a metal carport; the east side of the garage has a single-story addition of wood construction. A low brick wall with an entrance to the backyard connects the house to the garage along the east side of the yard. The house contributes to the Monte Vista local historic district.

- b. CASE HISTORY: On June 29, 2022, the applicant requested conceptual approval to demolish a small addition on the rear of the primary structure, construct a two-story addition to the rear of the primary structure, demolish an addition and carport on the garage, construct a two-story addition to the garage, and add a permeable terrace and low wall to the east side of the parcel. The Historic and Design Review Commission granted conceptual approval to all items with staff stipulations.
- c. DEMOLITION OF REAR ADDITION (PRIMARY): The applicant requests approval to demolish a one-story addition at the rear of the house. Staff finds the rear addition demolition appropriate since it is not original to the structure.
- d. REAR ADDITION (PRIMARY): The applicant requests approval to construct a two-story addition to the rear of the property, to include both interior space and a covered porch. Staff finds the proposed addition generally appropriate.
- e. ARCHITECTURAL DETAILS (MATERIALS, PRIMARY ADDITION): The Guidelines for New Construction 5.A.iii. and iv. note that new accessory structures should relate to the period of construction of the primary historic structure on the lot through the use of complementary materials and simplified architectural details. The applicant suggests a wood or Hardi board siding for the addition; should the applicant choose Hardi board, it should be installed with a 4" reveal, smooth side out.
- f. WINDOWS (PRIMARY ADDITION): The applicant proposes a combination of divided-lite aluminum clad sash windows with divided-lite transoms and aluminum-clad wood sliding windows. Windows on the house are one-over-one wood windows of equal sash size. Per Standard Specifications for Windows in Additions and New Construction, new windows on additions should relate to the windows of the primary historic structure in terms of materiality and overall appearance. Windows used in new construction should be similar in appearance to those commonly found within the district in terms of size, profile, and configuration. Staff finds the proposed window profiles generally appropriate.
- g. DEMOLITION OF ADDITIONS (GARAGE): The applicant requests approval to demolish a metal carport and one-story addition to the rear detached garage. Staff finds the demolitions appropriate since they are not original to the structure.
- h. ADDITION (GARAGE): The applicant requests approval to construct a two-story addition to the east side of the detached garage. The Guidelines for New Construction 5.A.iii. and iv. note that new accessory structures should relate to the period of construction of the primary historic structure on the lot through the use of complementary materials and simplified architectural details. Staff finds the garage addition generally conforms to guidelines.
- i. WINDOWS (GARAGE ADDITION): The applicant proposes aluminum clad windows on the second floor of the garage addition that are fixed asymmetrical windows with six lites. Windows on the house are one-over-one wood windows of equal sash size. Per Standard Specifications for Windows in Additions and New Construction, new windows on additions should relate to the windows of the primary historic structure in terms of materiality and overall appearance. Windows used in new construction should be similar in appearance to those commonly found within the district in terms of size, profile, and configuration. Staff finds the proposed window profiles on the garage addition generally appropriate
- j. BIKE AND UTILITY ENCLOSURES: The applicant proposes one bike enclosure and one utilities/mechanical enclosure that flank a proposed terrace. The enclosures are constructed of painted fixed metal panels that are 3.5 feet tall; the bike enclosure has a standing-seam metal roof that increases the structure's height to 4 feet. Historic Design Guidelines for Additions 3.A.i says any new materials introduced to the site as a result of an addition must be compatible with the architectural style and materials of the original structure. Staff finds the proposed bike and utility enclosures generally appropriate.
- k. TERRACE: The applicant proposes to replace existing greenspace with a pervious terrace, situated between the proposed bike and utility enclosures. Staff finds the terrace generally appropriate.
- 1. LANDSCAPING: The applicant proposes new landscaping along the west edge of the proposed biked and utility enclosures and terrace. Staff finds this conforms to guidelines.

RECOMMENDATION:

Staff recommends approval of item 1, demolition of a small addition on the rear of the primary structure, based on finding c.

Staff recommends approval of item 2, construction of a two-story addition to the rear of the primary structure, based on findings d, e, and f, with the following stipulations:

i. That should the applicant choose Hardi board, it be installed with a 4" reveal, smooth side out.

Staff recommends conceptual of item 3, demolition of an addition and carport on the garage, based on finding g.

Staff recommends approval of item 4, construction of a two-story addition to the garage, based on findings h and i.


Staff recommends approval of item 5, construction of bike and utility enclosures, based on item j, with the following stipulation:

i. That the applicant provides material details or samples of the proposed metal cladding and roofing for the enclosures.

Staff recommends approval of items 6 and 7, construction of a permeable terrace and addition of landscaping, based on findings k and l, with the following stipulation:

i. That the applicant submits a comprehensive landscaping plan.

City of San Antonio One Stop

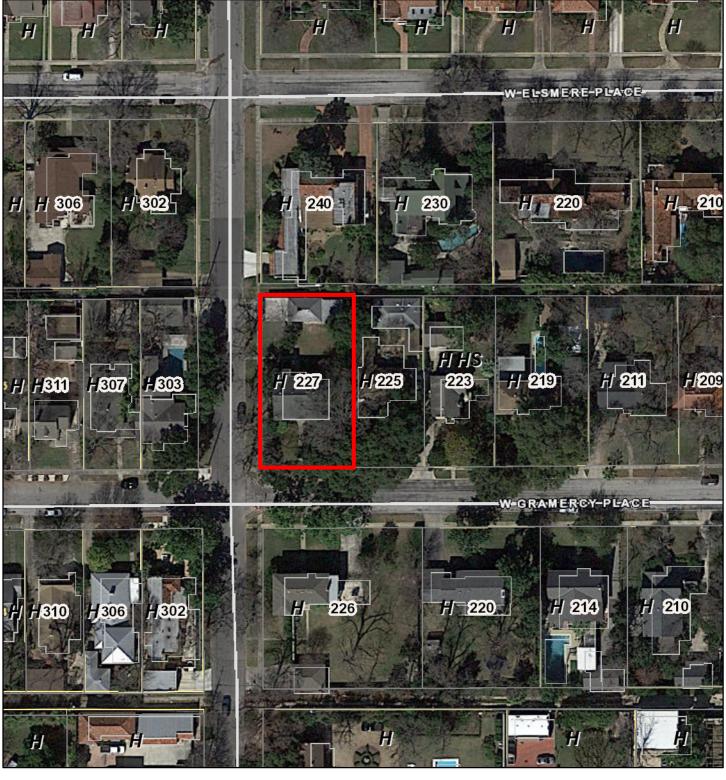

June 23, 2022

CoSA Addresses

Zoning Overlay Label

Community Service Centers

COSA City Limit Boundary

1:1,000

0 0.0075 0.015 0.03 mi
0 0.0125 0.025 0.05 km

CoSA Parcels

BCAD Parcels

227 W Gramercy Place

Project Description – Office of Historic Preservation 11/11/2022

To:

Office of Historic Preservation

Owner, Applicant is requesting review and approval from the Office of Historic Preservation to:

Construct a new addition to the main house and a new addition to the existing garage. Both additions are located behind the existing structure that faces the street. The main house addition will allow for a full-size kitchen on the ground floor of the main house with a relocated bedroom above. The garage addition will be used as a living space that looks out on the back yard.

The existing house is a masonry structure built in the early 1900's and designed by Harvey P. Smith.

Location - The main house addition is on the back side of the house and completely hidden from view from Gramercy Place. Along Belknap, the addition is behind the existing back wing of the house and along the eave of the existing roof.

Materials - The front of the house incorporates wood columns and wood trim at the front porch. In response to the existing brick and existing wood trim, the new addition will comprise of a simple two-story wood-sided addition with an attached porch. The ground level back porch is open air while the second floor is a screened-in porch. All exterior surfaces of the addition will be painted.

Garage Addition - The project will include a removal of the existing carport that faces Belknap and the existing addition to the original garage at the East of the garage. The existing wood garage doors and windows will be refurbished and repainted. as part of the regular maintenance of the structure. The existing man door into the garage are not original and will be replaced with painted wood door panels. The garage addition will be located to the east of the original structure and adheres to the setback requirements along the alley. The height of the addition is 19'-3" from the existing grade. The addition stands 3'-2" above the ridge of the existing garage. The addition will be constructed as an enclosed porch comprised of a clad wood structure with painted wood sashes in the openings. All exterior surfaces of the addition will be painted with a uniform flat finish.

Submitted on behalf of owners Aaron and Lori Prado.

Respectfully,
Darian Grant Mason, Architect
Peli and Mason Architecture Shop
1149 E Commerce, Suite 200, San Antonio, TX 78205
e: darian@pamastx.com p: (210) 504-6494

Prado Residence Architectural Specifications Abbreviated

Péli And Mason Architecture Shop

1149 E. Commerce Street, Suite 200 San Antonio, TX 78205 June 07, 2022 San Antonio, Texas

Project Information

Project Name: Prado Residence
Owner: Aaron and Lori Prado
Project Address: 227 W Gramercy Place
San Antonio, TX 78212

Architect: Peli and Mason Architecture Shop

Project Architect: Darian Grant Mason

Office Address: 1149 E. Commerce Street, Suite 200

San Antonio, TX 78205

Phone: 202.957.5026

E-mail: darian@pamastx.com

Structural Engineer: Gessner Engineering

Project Manager: Evan Roe

Office Address: 4455 Camp Bowie Boulevard, Suite 210

Ft Worth, Texas 76107

Existing Conditions - 02 00 00

Existing Primary Structure:

Front Porch – Painted wood columns, painted horizontal wood siding shed attached to main roof structure, Masonry and Tile Porch deck.

Exterior Walls - Masonry veneer on wood studs

Doors – Wood, assumed original to structure

Windows- Wood, assumed original to structure

Roof – Composite Shingle

Addition to be removed – Wood framed shed structure, painted horizontal wood siding, Composite Shingle roof

Existing Accessory Structures:

Exterior Walls – Masonry Veneer on wood studs at original garage.

Man Doors: Hollow Core doors, not original

Garage Overhead Door: Painted Wood, assumed original to structure.

Windows, Painted Wood, assumed original to structure.

Roof – Composite Shingle

Carport to be removed – Metal posts with metal girders and roof.

Garage addition to be removed - Wood Siding panel on wood studs, flat membrane roof.

Existing Site Structures:

Garden Wall: Triple wythe loadbearing masonry wall

Prado Residence Architectural Specifications Abbreviated

Péli And Mason Architecture Shop

1149 E. Commerce Street, Suite 200 San Antonio, TX 78205 June 07, 2022 San Antonio, Texas

New Construction - Exterior Finishes

Primary Structure Addition:

Exterior Walls – Painted Horizontal siding, 4" Exposure, Rot resistant wood; mahogany or

similar. Alternate: Hardie board siding.

Exposed Framing - Painted 6"x6" Wood members, Rot resistant wood; mahogany or similar.

Wood Deck - Stained 5/4" x4" T&G Wood decking

Exterior Door - Painted Metal clad wood door; Pella or Similar Windows - Painted Metal clad wood window; Pella or Similar Screened Sashes - Painted Wood sashes, tear resistant metal screen.

Accessory Structure Addition:

Exposed Foundation - Board Formed Concrete Foundation

Exposed Framing - Painted wood members, Rot resistant wood; mahogany or similar.

Clad Framing - Painted wood trim clad over, structural steel as required.

Wood Deck - Stained 5/4" x4" T&G wood decking

Exterior Door - Painted Metal clad wood door; Pella or Similar Windows - Painted Metal clad wood window; Pella or Similar

Fixed Panel Sashes - Painted Fixed wood panels with fixed slats. Rot resistant wood; mahogany or

similar.



Scale: 1/8"=1'-0"

Not for construction, permitting or regulatory approval

dateNovember 10, 2022



project name

sheet title

As-Built Site Pl

revisions

drawing number

R1.0

11/10/2022

1 SITE PLAN



GENERAL NOTES

1. GENERAL CONTRACTOR TO NOTIFY ARCHITECT OF ANY CONDITIONS UNCOVERED UPON DEMOLITION

LEGEND

EXISTING MASONRY SITE WALL

/// NEW ADDITION

DOWNSPOUT

PANEL ELECTRIC SERVICE

HOSE BIB

NOTES

1 UTILITY YARD

2 NEW PERVIOUS TERRACE

3 BIKE STORAGE

4 EXISTING GATE AT EXISTING MASONRY SITE WALL

(5) HERB GARDEN

(6) NEW PAVED PATIO

(7) RELOCATED WROUGHT IRON FENCE

(8) EXISTING CARPORT TO BE REMOVED


9 EXISTING FENCING TO BE RELOCATED

(10) NEW PAVED WALK

Not for construction, permitting or regulatory approval

date: November 27, 2022

architect

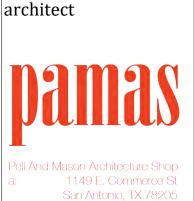

project name

Prado Residence Remodel and Addition 227 W. Gramercy Place, San Antonio, TX 78212

sheet title

Site Plan

revisions

drawing number

11/27/2022

Scale: 1/8"=1'-0"



PRADO RESIDENCE - REMODEL AND ADDITION
80% Construction Set
November 11, 2022

Not for construction, permitting or regulatory approval

dateNovember 11, 2022

Péli And Mason Architecture Shop a: 1149 E. Commerce St San Antonio, TX 78205

project name

Prado Residence
Remodel and Addition
227 W. Gramercy Place,
San Antonio, TX 78212

sheet title

Cover Page

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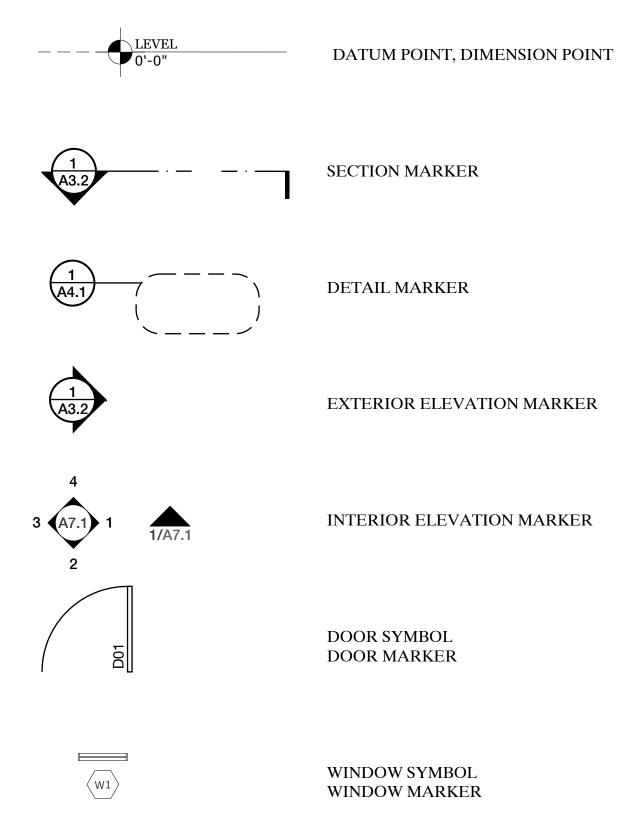
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revisions

drawing number

G1.0

Drawing Symbols Project Information Drawing List



Client:	Aaron and Lori Prado	Archite
Project Name:	Prado Residence - Remodel and Addition	1. G1
Address:	227 W. Gramercy Place	2. G1
	San Antonio, TX 78212	
Legal Description:	NCB 3970 BLK D Lot 29	3. R1
Zoning:	R-5	4. R1
Neighborhood:	Monte Vista II Historic (SA)	5. D1
		5. D1
Archi	tect and Engineer of Record	6. A1
		7. A1
Architect:	Peli and Mason Architecture Shop	8. A1
	1149 E. Commerce St, Suite 200	9. A1
	San Antonio, TX 78205	
	Contact: Darian Mason	10. A2
	p: 210 504 6494	11. A2
	e: darian@pamastx.com	12. A2
Structural Engineer:	Gessner Engineering	12 40
-	11913 Starcrest Dr	13. A3 14. A3
	San Antonio, TX 78247	15. A3
	Contact:	16. A3
	p:	10. 11.
	e:	17. A4
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	Applicable Codes	22. A6
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		24. A6
Fire Code	International Fire Code (IFC 2018)	25. A6
		26. A6
Mechanical Code	International Mechanical Code (IMC 2018)	27. A7
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Plumbing Code	International Plumbing Code (IPC 2018)	29. A7
Electrical Code	National Electrical Code (NEC 2017)	30. A7
Electrical Code	National Electrical Code (NEC 2017)	31. A7

International Residential Code Chapter 11 (IRC 2018)

City of San Antonio Unified Development Code

Energy Code

COSA UDC

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	<u>-</u>

Not for construction, permitting or regulatory approval dateNovember 11, 2022

architect

Péli And Mason Architecture Shop
a: 1149 E. Commerce St
San Antonio, TX 78205

project name

Prado Residence
Remodel and Addition
227 W. Gramercy Place,
San Antonio, TX 78212

sheet title

Project Information

phase CD

revisions

drawing number

G1.1



seal

Not for construction, permitting or regulatory approval

dateNovember 11, 2022



project name

Frado KesidenceRemodel and Addition
227 W. Gramercy Place.

sheet title

As-Built Site Plan

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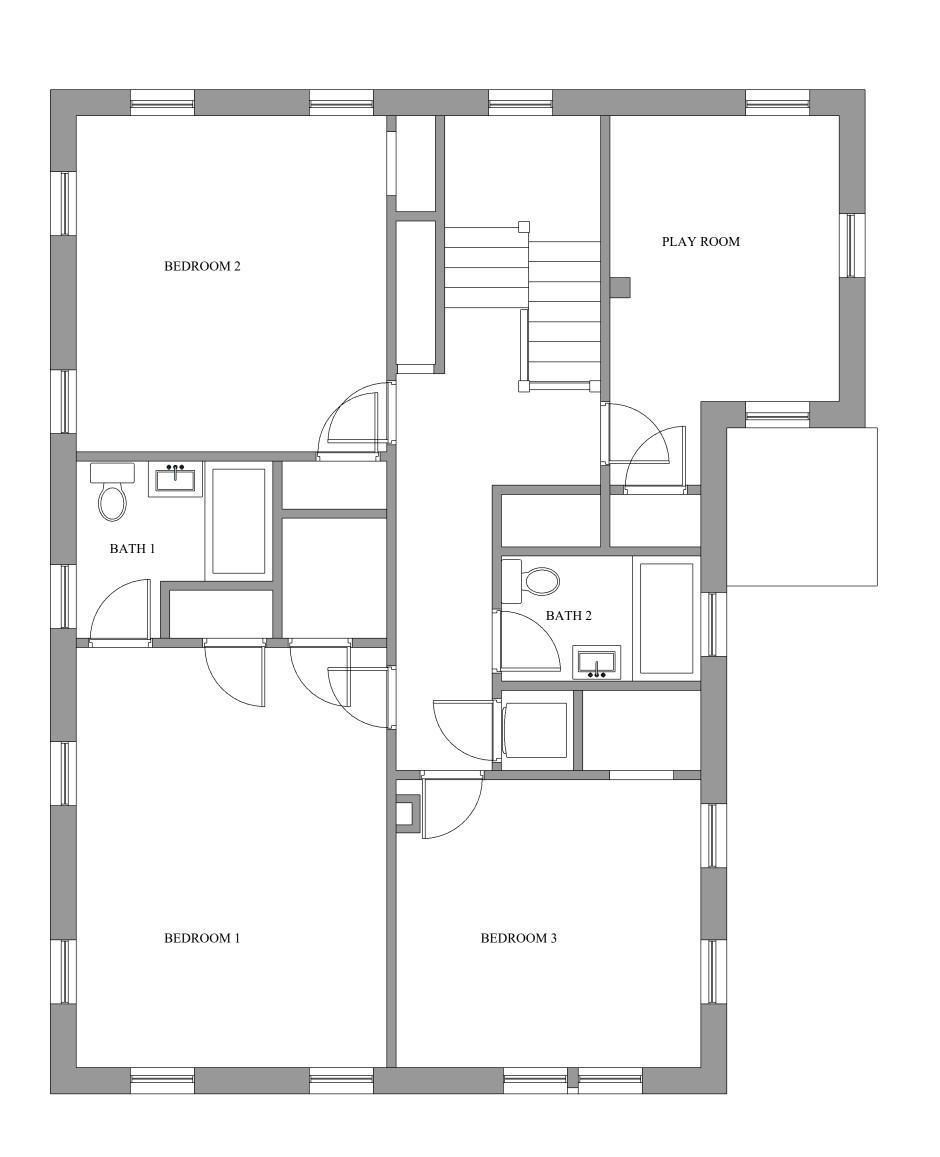
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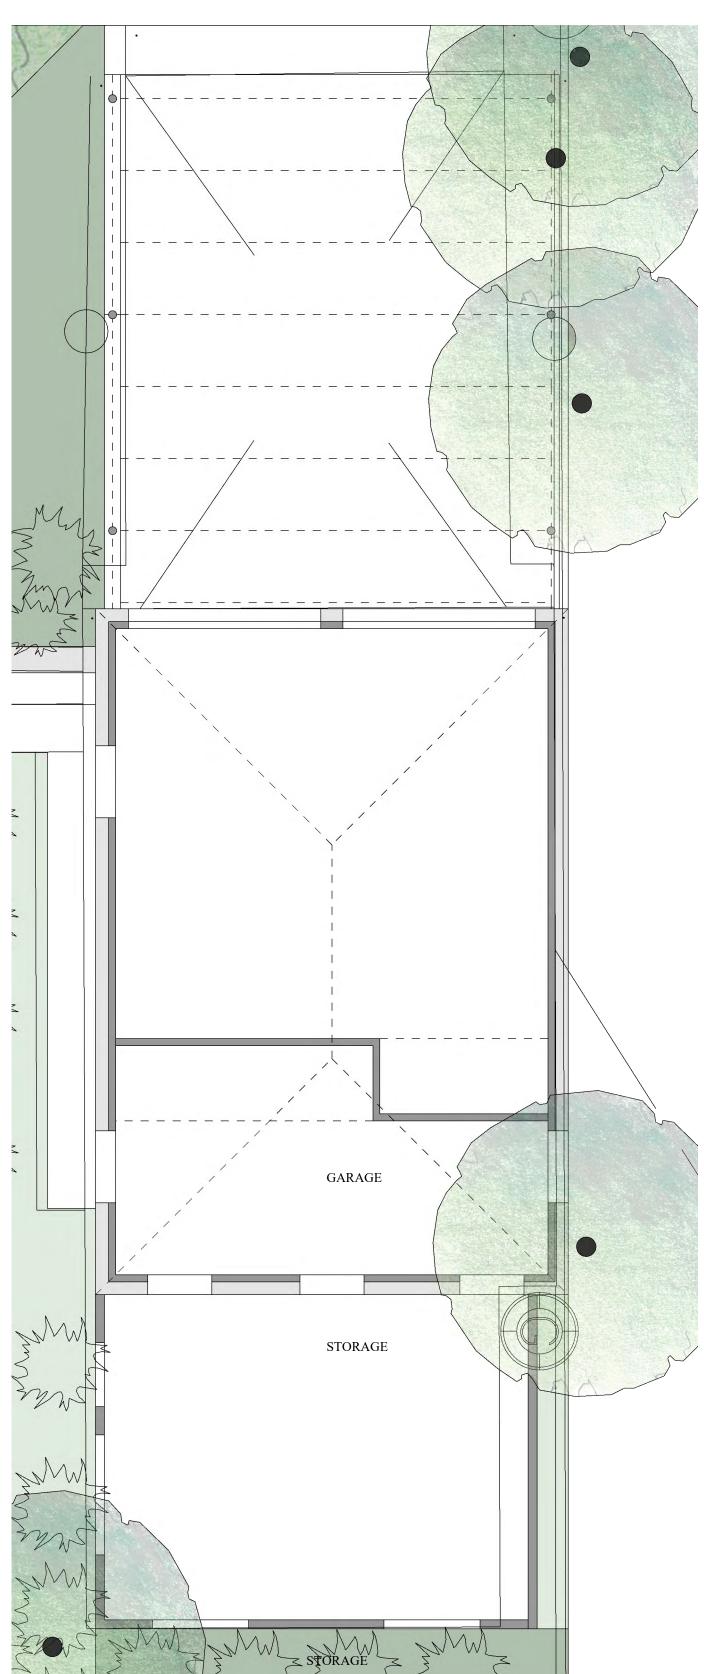
11/11/2022

Scale: 1/8"=1'-0"



3 AS - BUILT SECOND FLOOR PLAN - MAIN HOUSE





Not for construction, permitting or regulatory approval

dateNovember 11, 2022

architect

1149 E. Commerce St San Antonio, TX 78205

project name

Prado Residence Remodel and Addition

sheet title

As-Built Floor P

revisions

drawing number

R1.1 11/11/2022

DEMOLISH STRUCTURE — REMOVE AND PROTECT EXISTING GARAGE DOORS FOR REFURBISHMENT **BUTLER'S** PANTRY DINING ROOM REMOVE AND PROTECT - EXISTING GARAGE DOORS GARAGE FOR REFURBISHMENT – DEMOLISH

SLAB —

DEMOLISH **EXISTING** HARDSCAPE

GENERAL NOTES

- 1. GENERAL CONTRACTOR TO NOTIFY ARCHITECT OF ANY CONDITIONS UNCOVERED UPON DEMOLITION
- 2. GENERAL CONTRACTOR TO PROTECT EXISTING FLOORING, CEILING, INTERIOR AND EXTERIOR FINISHES, WHERE NOT REMOVED.
- 3. REFERENCE ARCHITECTURAL PLANS FOR NEW FRAMED WALL AND OPENING SIZES, LOCATIONS.


LEGEND

REFER TO A6.3 PROJECT SCHEDULES FOR SPECIFICATIONS

WALLS - EXISTING

I___ WALLS TO BE DEMOLISHED

TTT EXTERIOR PATIO TO BE DEMOLISHED

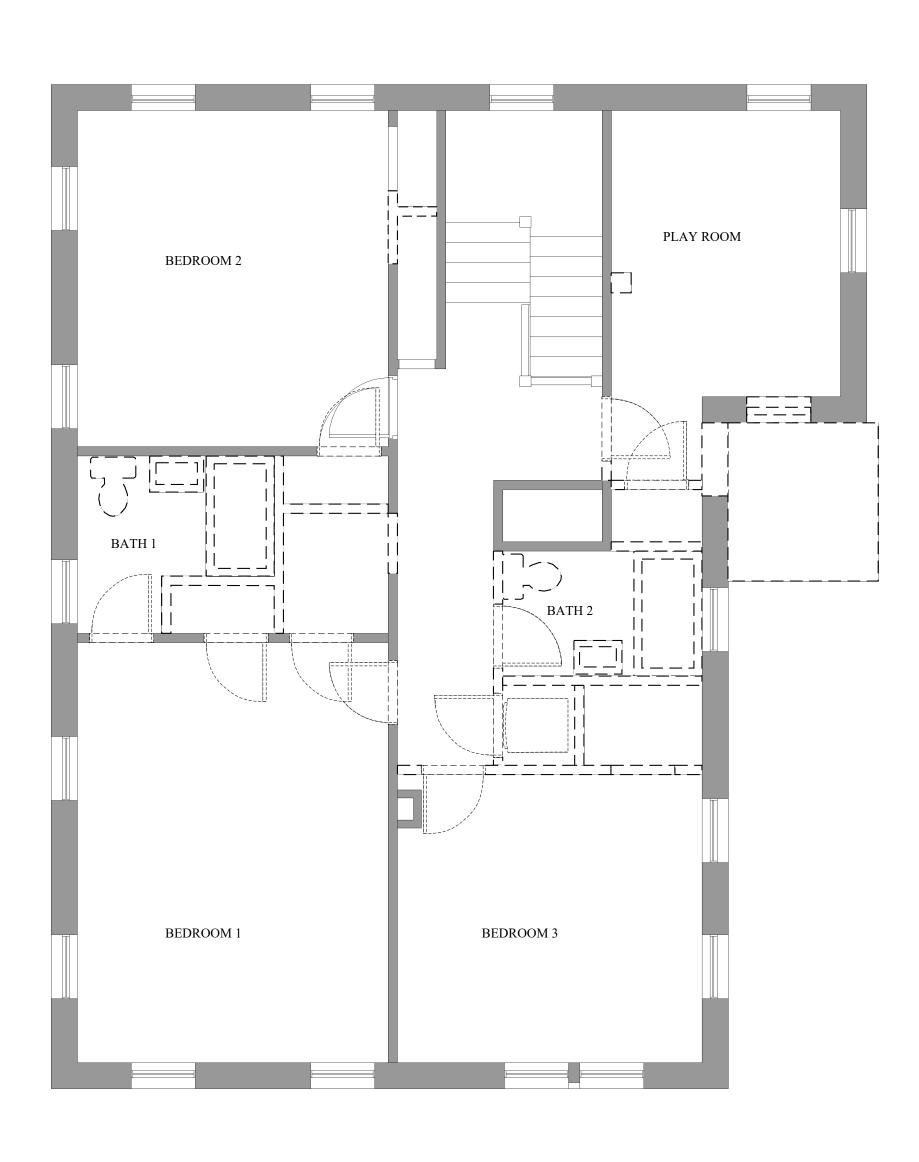

1149 E. Commerce St San Antonio, TX 78205

project name

Not for

construction,

permitting or

regulatory approval

dateNovember 11, 2022

architect

Residence I and Addition

sheet title

Remodel

revisions

drawing number

11/11/2022

2 DEMOLITION FIRST FLOOR PLAN - GARAGE

Scale: 1/4"=1'-0"

DEMOLISH SLAB —

STUDY

LIVING ROOM

DEMOLITION FIRST FLOOR PLAN - MAIN HOUSE

1 SITE PLAN



GENERAL NOTES

1. GENERAL CONTRACTOR TO NOTIFY ARCHITECT OF ANY CONDITIONS UNCOVERED UPON DEMOLITION

LEGEND

EXISTING MASONRY SITE WALL

/// NEW ADDITION

DOWNSPOUT

PANEL ELECTRIC SERVICE

HOSE BIB

NOTES

1 UTILITY YARD

2 NEW PERVIOUS TERRACE

3 BIKE STORAGE

4 EXISTING GATE AT EXISTING MASONRY SITE WALL

(5) HERB GARDEN

(6) NEW PAVED PATIO

(7) RELOCATED WROUGHT IRON FENCE

(8) EXISTING CARPORT TO BE REMOVED


9 EXISTING FENCING TO BE RELOCATED

(10) NEW PAVED WALK

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date: November 27, 2022

architect

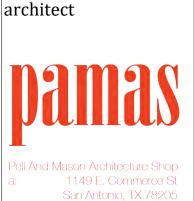

project name

Prado Residence Remodel and Addition 227 W. Gramercy Place, San Antonio, TX 78212

sheet title


Site Plan

revisions

drawing number

11/27/2022

Scale: 1/8"=1'-0"

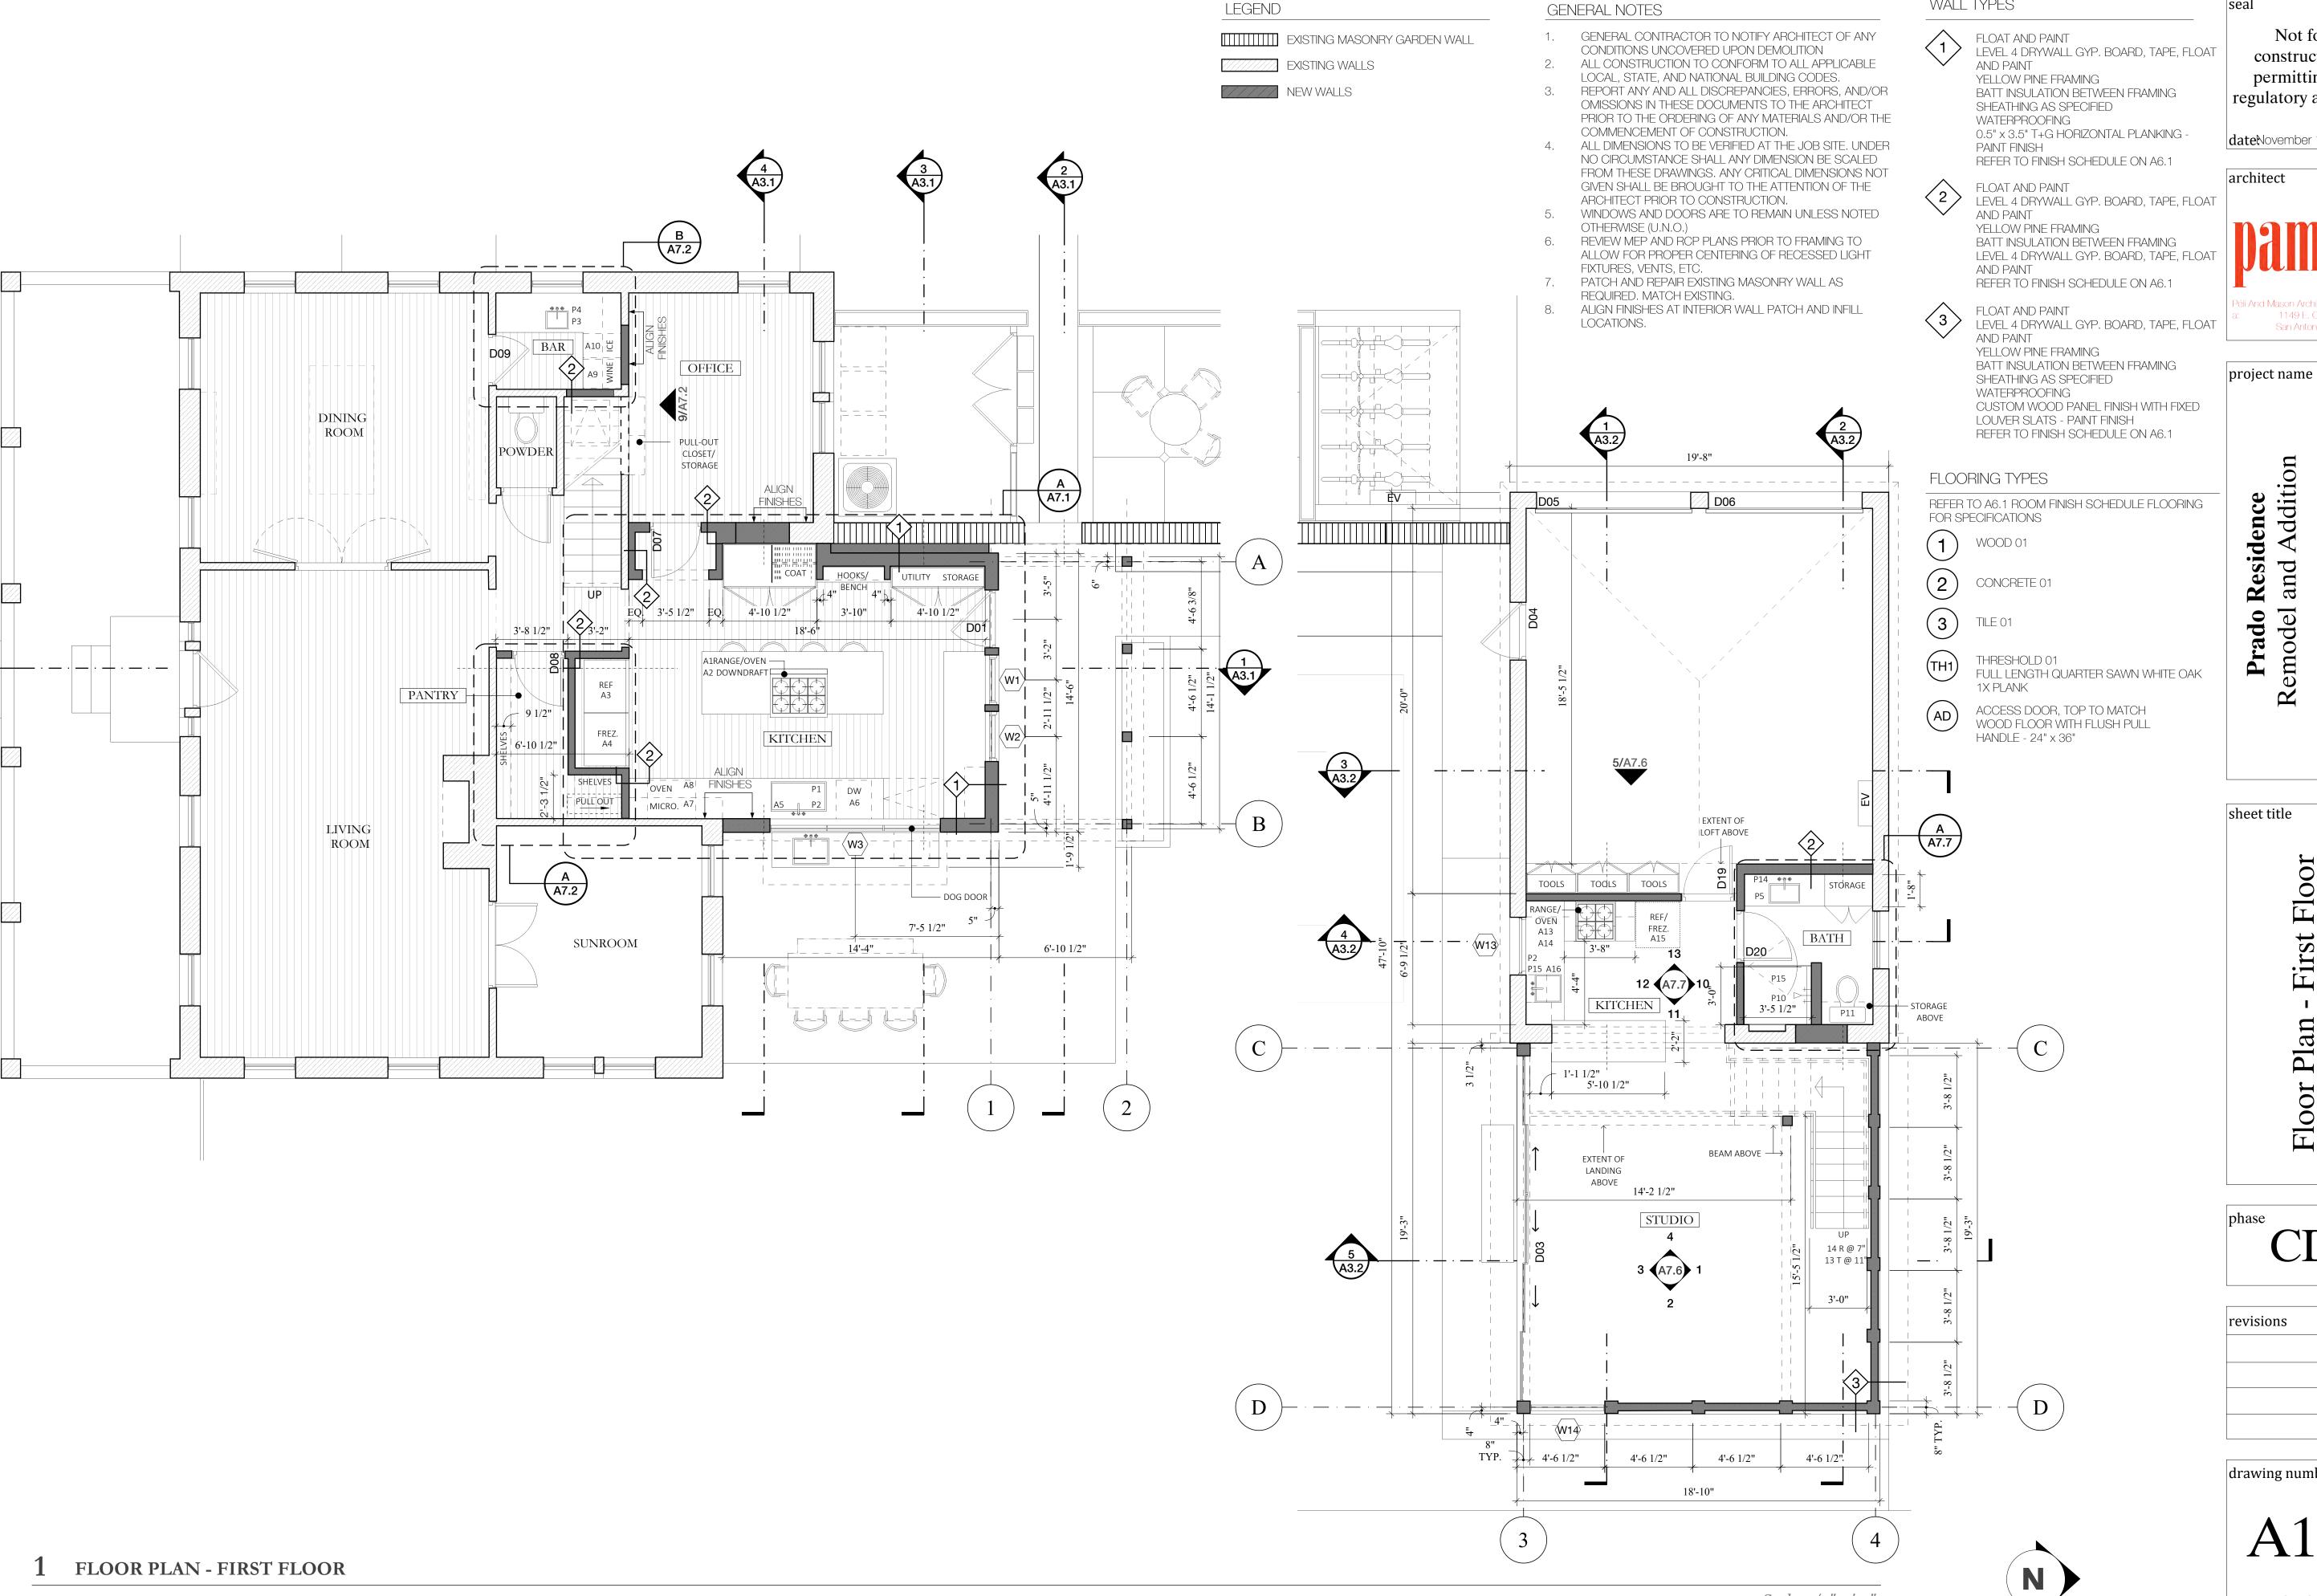

WALL TYPES

permitting or regulatory approval

dateNovember 11, 2022

Residence and Addition

Remodel

Not for

construction,

1149 E. Commerce St

San Antonio, TX 78205

227 W. Gramercy F San Antonio, TX 7

architect


sheet title

revisions

drawing number

11/11/2022

Scale: 1/4"=1'-0"

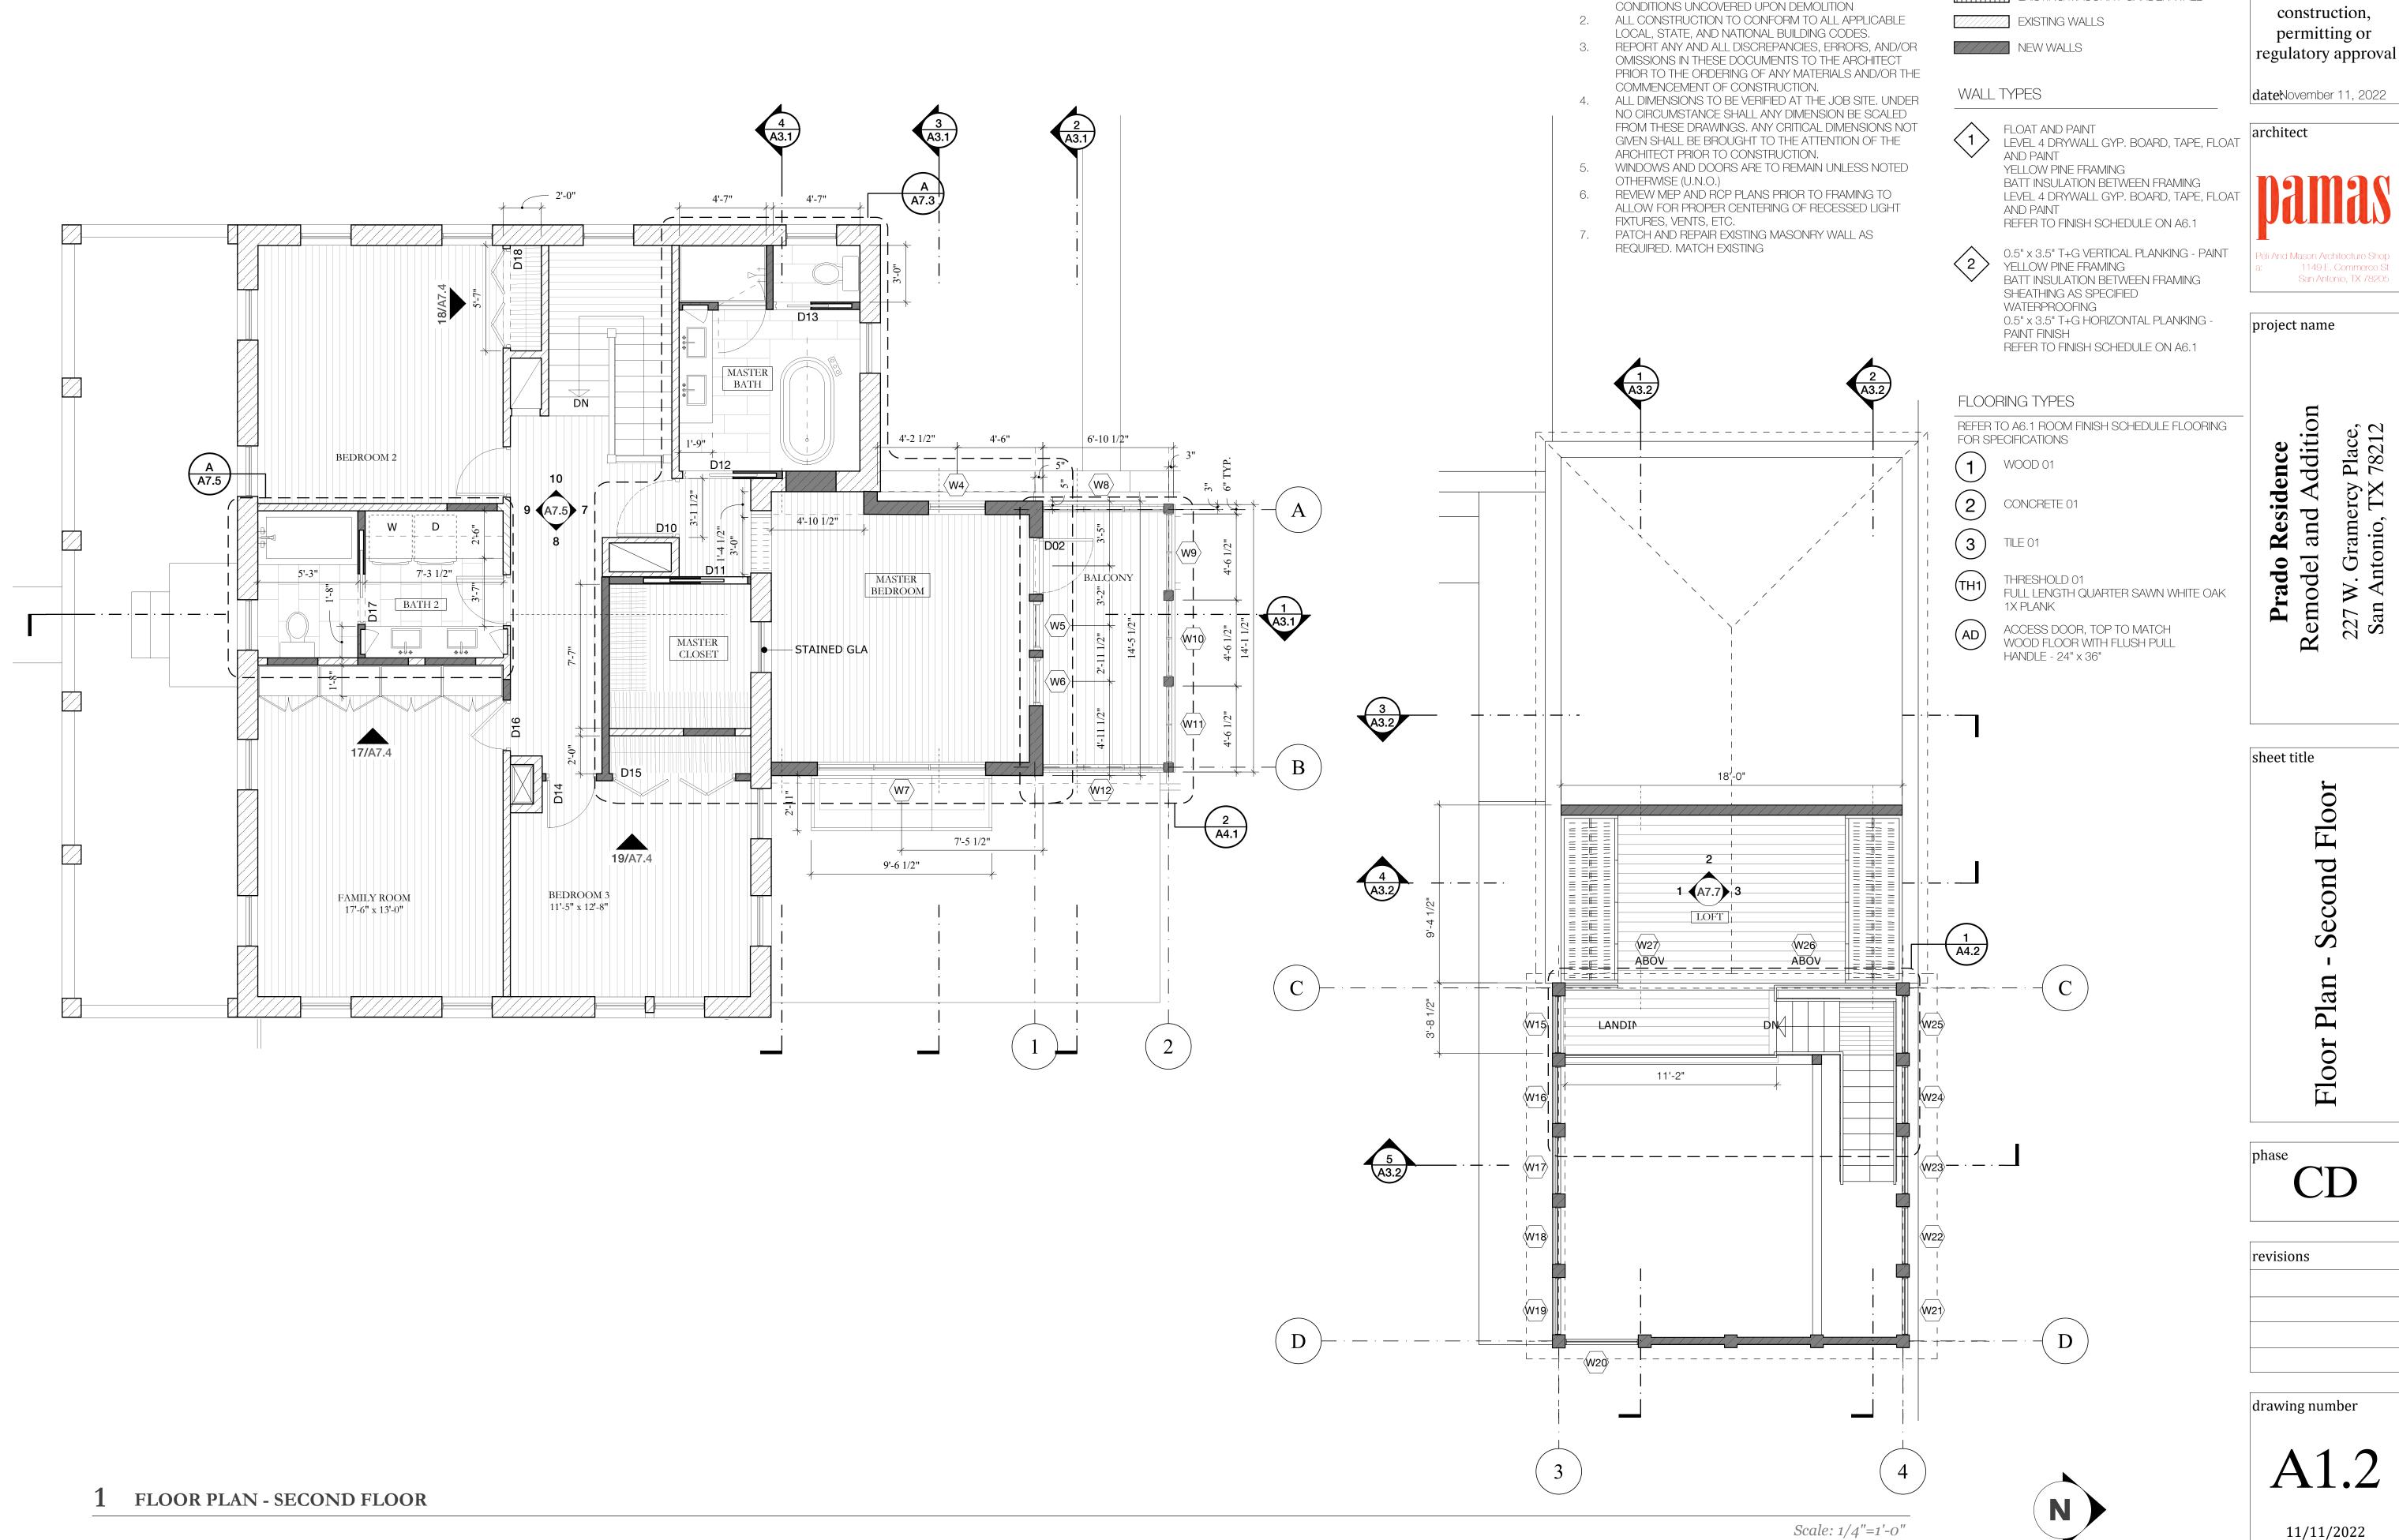


Not for

EXISTING MASONRY GARDEN WALL

LEGEND

GENERAL NOTES

1. GENERAL CONTRACTOR TO NOTIFY ARCHITECT OF ANY

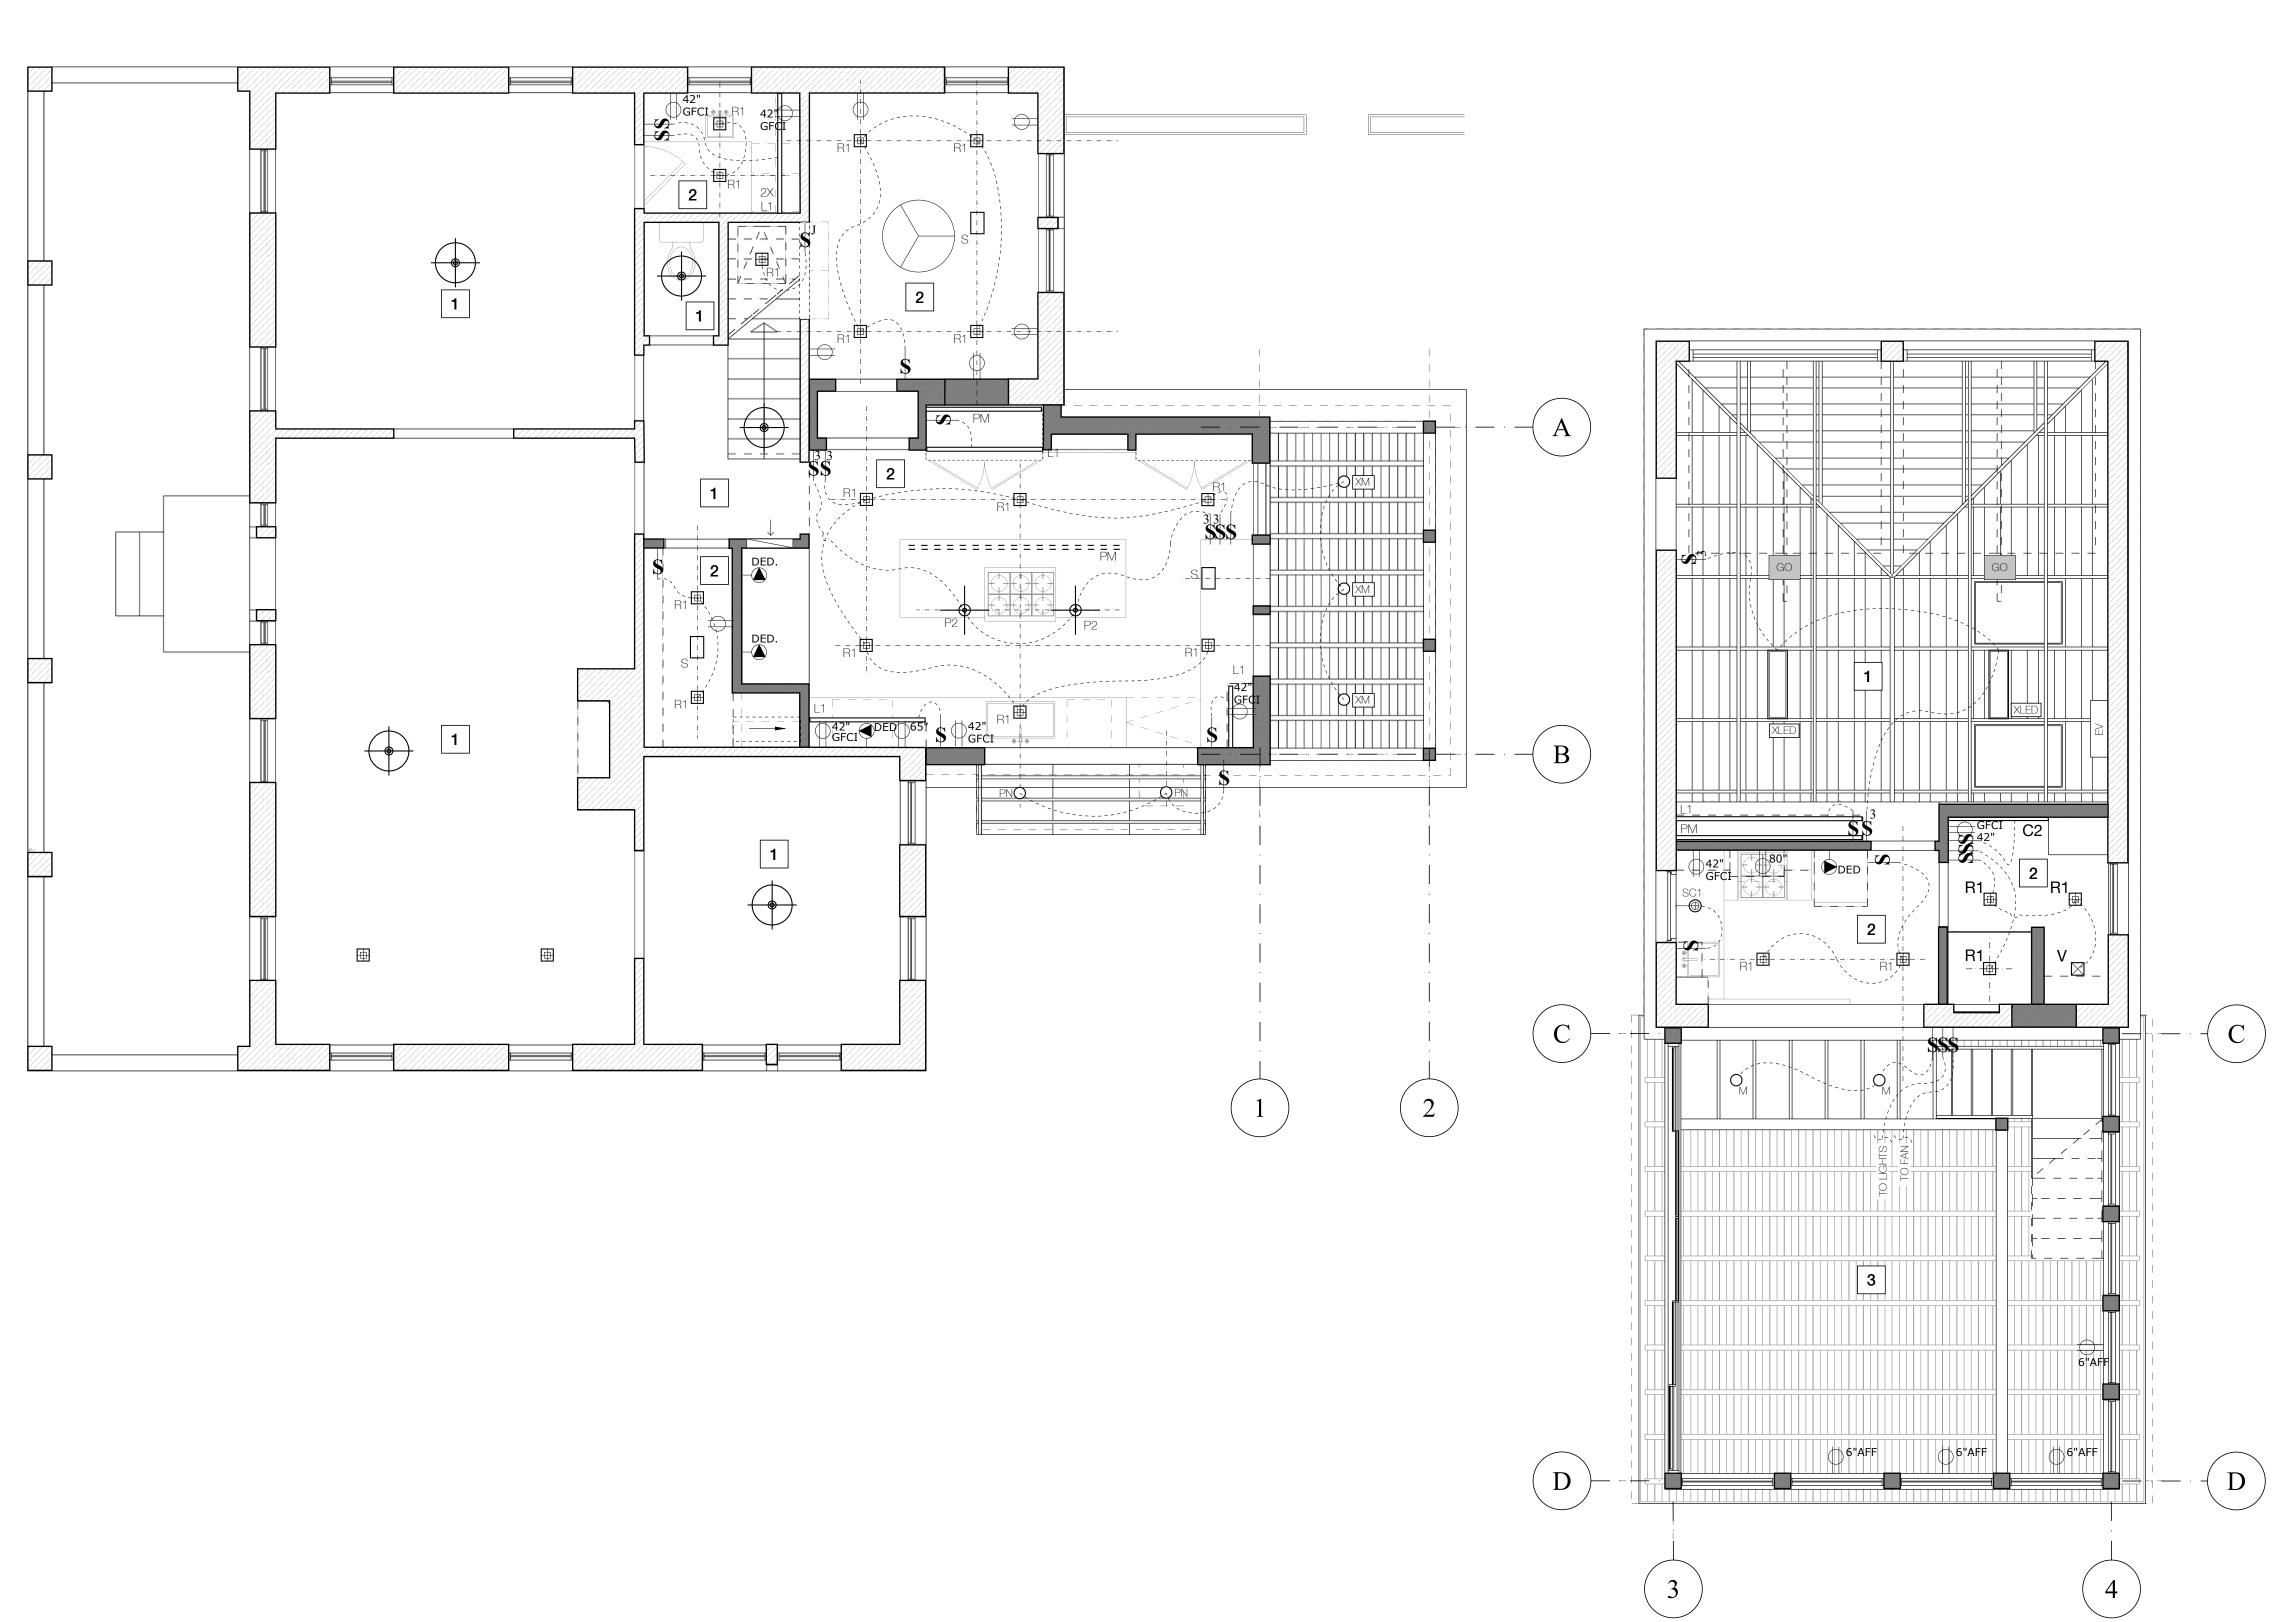

REFLECTED CEILING PLAN - FIRST FLOOR

Scale: 1/4"=1'-0"

GENERAL NOTES

- 1. GENERAL CONTRACTOR TO NOTIFY ARCHITECT OF ANY CONDITIONS UNCOVERED UPON DEMOLITION
- GENERAL CONTRACTOR TO SUBMIT CUTSHEETS TO ARCHITEC AND OWNER PRIOR TO ORDERING OR FABRICATION
- 3. CONTRACTOR TO PROVIDE MATERIAL, FINISH AND PAINT SAMPLES TO OWNER AND ARCHITECT FOR APPROVAL PRIOR TO ORDERING OR FABRICATION

LEGEND

REFER TO A6.1 ROOM SCHEDULES FOR FINISHES

REFER TO A6.3 PROJECT SCHEDULES FOR SPECIFICATIONS

CEILING FAN - EXISTING (TO BE PROTECTED)

OUTDOOR CEILING FAN

PENDANT @ ISLAND

PENDANT

MONOPOINT

P1

EXTERIOR MONOPOINT

RECESSED DOWNLIGHT

RECESSED DOWNLIGHT - RETROFIT CUSTOM MIRROR WITH

INTEGRATED LIGHT FIXTURE L1 LINEAR TAPE LIGHT

PICTURE LIGHT

4" SQUARE SURFACE MOUNT LED

EXISTING SCONCE - TO BE HARDWIRED

EXHAUST VENT: BROAN QTXE080 VERY QUIET SERIES ALT.: PANASONIC FV-08VF2, WHITE FINISH, WHISPERFIT 80CFM LOW PROFILE

SUPPLY AIR GRILLE

EXISTING GARAGE OPENER

PM PLUGMOLD - INSTALLED TO THE UNDERSIDE OF UPPER CABINETS OR SHELVES -LEGRAND AL SERIES OR EQUAL

EXISTING ELECTRICAL OUTLET: EX EX EXISTING FACEPLATES

NEW ELECTRICAL OUTLET: === 42" GFCI FACEPLATES TO MATCH EXISTING

CLOCK OUTLET CL

EXT EXTERIOR ELECTRICAL OUTLET SWITCHED ELECTRICAL OUTLET: BALDWIN FACEPLATES

SWITCH


Finish Notes

GO

- EXISTING CEILING TO REMAIN
- LATEX PAINT ON GYPSUM BOARD / STUCCO drawing number FINISH: PAINT 01
- DOUGLAS FIR 1X4 T+G CEILING FINISH: CLEAR COAT
 - DOUGLAS FIR 1X4 T+G CEILING, EXPOSED 3X8" BEAMS FINISH: PAINTED REFER TO FINISH SCHEDULE

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dateNovember 11, 2022

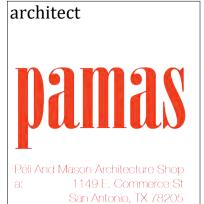


project name


Residence I and Addition Remodel

sheet title

eiling First Floor Reflected C

revisions

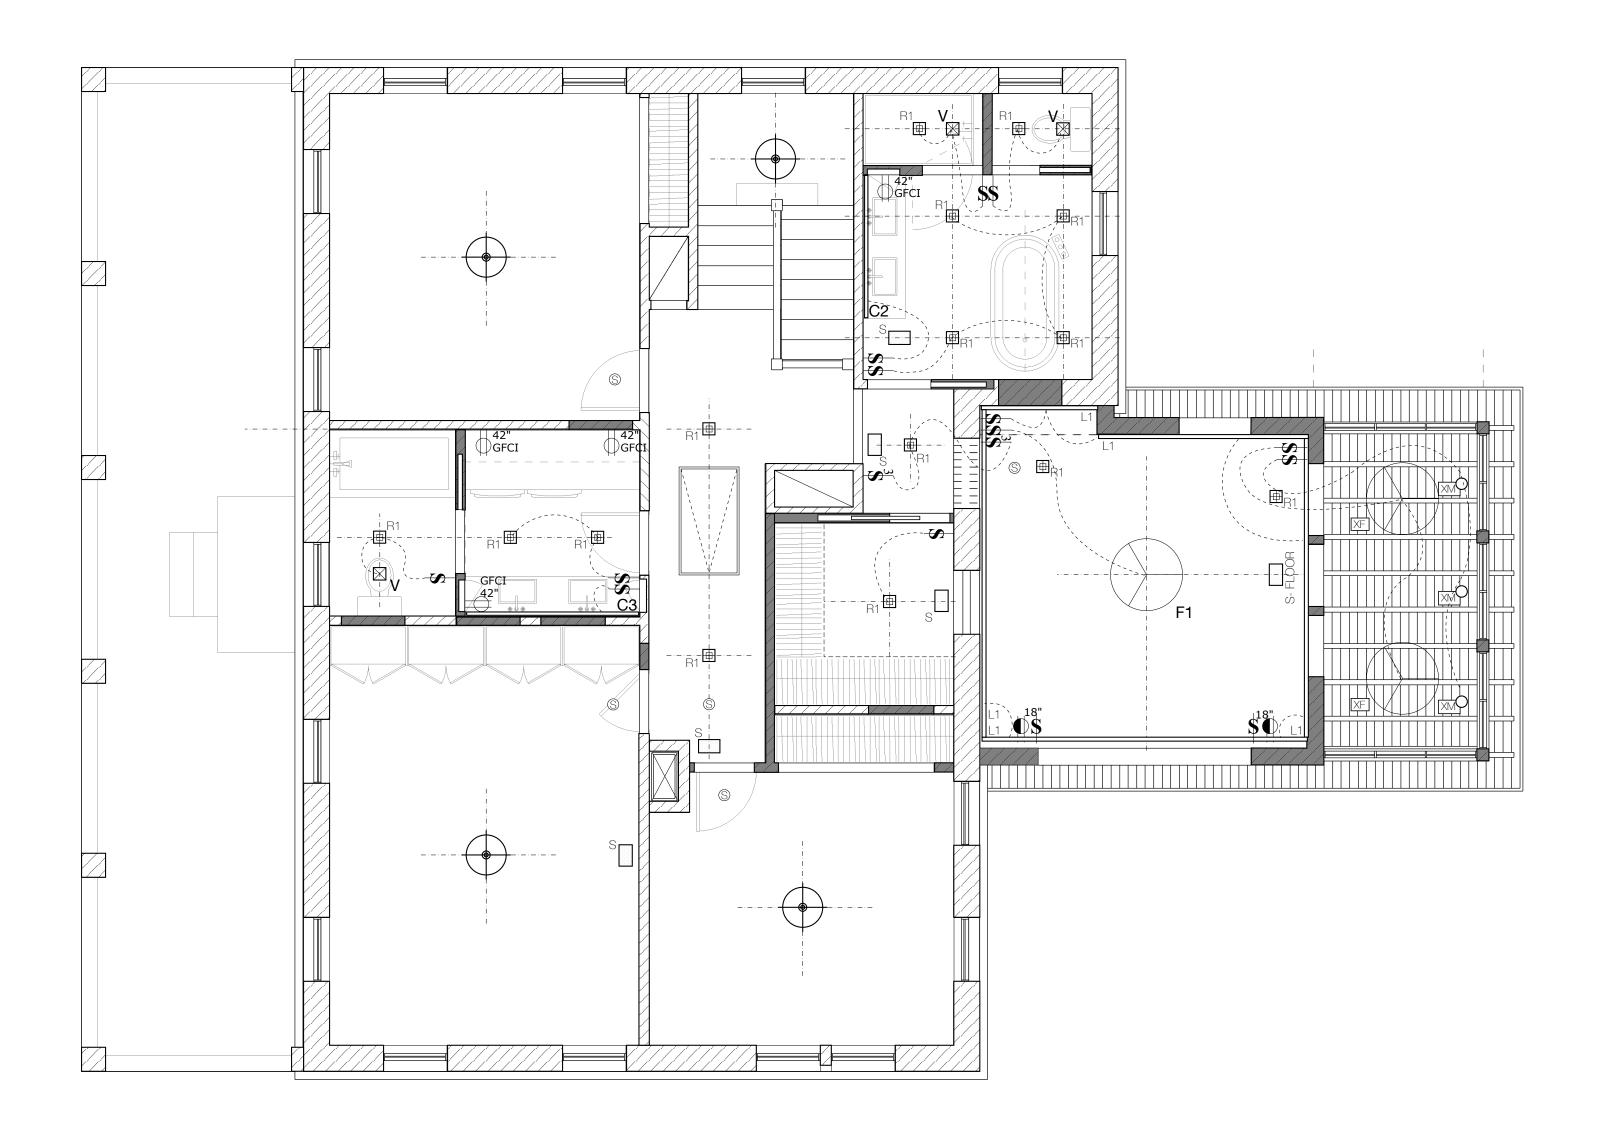

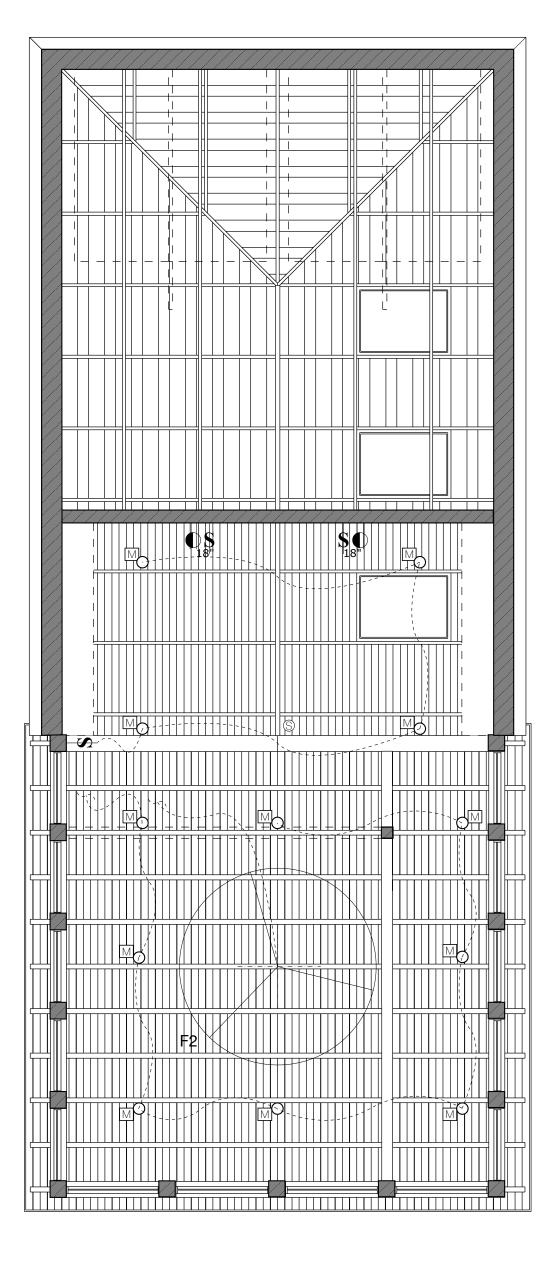

REFLECTED CEILING PLAN - SECOND FLOOR

GENERAL NOTES

1. GENERAL CONTRACTOR TO NOTIFY ARCHITECT OF ANY CONDITIONS UNCOVERED UPON DEMOLITION


2. GENERAL CONTRACTOR TO SUBMIT CUTSHEETS TO ARCHITEC AND OWNER PRIOR TO ORDERING OR FABRICATION

3. CONTRACTOR TO PROVIDE MATERIAL, FINISH AND PAINT SAMPLES TO OWNER AND ARCHITECT FOR APPROVAL PRIOR TO ORDERING OR FABRICATION


LEGEND

REFER TO A6.1 ROOM SCHEDULES FOR **FINISHES**

REFER TO A6.3 PROJECT SCHEDULES FOR SPECIFICATIONS

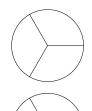

CEILING FAN

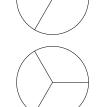


OUTDOOR CEILING FAN



PENDANT P1



PENDANT @ ISLAND

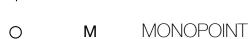

EXTERIOR MONOPOINT

RECESSED DOWNLIGHT

RECESSED DOWNLIGHT - RETROFIT

SURFACE MOUNTED, EXISTING

SURFACE MOUNTED

CUSTOM MIRROR WITH INTEGRATED LIGHT FIXTURE

LINEAR TAPE LIGHT

PL PICTURE LIGHT

4" SQUARE SURFACE MOUNT LED

EXISTING SCONCE - TO BE HARDWIRED

EXHAUST VENT: BROAN QTXE080 VERY QUIET SERIES ALT.: PANASONIC FV-08VF2,

WHITE FINISH, WHISPERFIT 80CFM LOW PROFILE

SUPPLY AIR GRILLE

PLUGMOLD - INSTALLED TO THE UNDERSIDE OF UPPER CABINETS OR SHELVES -LEGRAND AL SERIES OR EQUAL

EXISTING ELECTRICAL OUTLET: EX EX EXISTING FACEPLATES

NEW ELECTRICAL OUTLET: GFCI FACEPLATES TO MATCH EXISTING

CLOCK OUTLET \longrightarrow CL

EXT EXTERIOR ELECTRICAL OUTLET SWITCHED ELECTRICAL

OUTLET: BALDWIN FACEPLATES

Finish Notes

S

EXISTING CEILING TO REMAIN


LATEX PAINT ON GYPSUM BOARD / STUCCO drawing number FINISH: PAINT 01

DOUGLAS FIR 1X4 T+G CEILING FINISH: CLEAR COAT

> DOUGLAS FIR 1X4 T+G CEILING, EXPOSED 3X8" BEAMS FINISH: PAINTED REFER TO FINISH SCHEDULE

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dateNovember 11, 2022

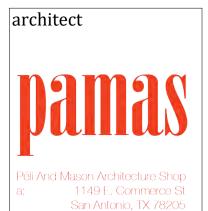

project name

Prado Residence Remodel and Addition

sheet title

Reflected Ceiling I Second Floor Ceiling

revisions



GENERAL NOTES

- 1. GENERAL CONTRACTOR TO NOTIFY ARCHITECT OF ANY CONDITIONS UNCOVERED UPON DEMOLITION
- 2. REFRENCE STRUCTURAL PLANS FOR FRAMING MEMBER SIZES, LOCATIONS AND CONNECTION
- 3. CONTRACTOR TO PROVIDE MATERIAL, FINISH AND PAINT SAMPLES TO OWNER AND ARCHITECT FOR APPROVAL PRIOR TO ORDERING OR FABRICATION
- 4. EXISITING BRICK CLADDED STRUCTURE TO REMAIN. SOILED OR DAMAGED BRICK BE CLEANED AND OR REPAIRED, TYP. UNLESS NOTED OTHERWISE. REFER TO A1.0
- 5. EXISITING DOORS AND WINDOWS TO REMAIN, TYP. UNLESS NOTED OTHERWISE. REFER TO A1.0
- 6. EXISITING GARDEN WALL TO REMAIN, TYP. UNLESS NOTED OTHERWISE. REFER TO A1.0

KEYNOTES

- (1) EXISTING DOOR TO REMAIN/ REFURBISH TO MATCH
- 2 NEW PAINTED WOOD FRAMING MEMBER
- 3 NEW PAINTED WOOD CLADDING
- 4 NEW WINDOW METAL CLAD
- (5) NEW DOOR METAL CLAD
- 6 NEW SCREENED PORCH PAINTED WOOD SASHES
- 7) NEW AWNING METAL SUPPORT WITH GLASS PANELS
- (8) NEW PHOTOVOLTAIC PANELS

Scale: 1/4"=1'-0"

sheet title revisions NEIGHBOR'S PROPERTY 10'ALLEY


2 WEST SITE ELEVATION

Scale: 1/4"=1'-0"

Not for construction, permitting or regulatory approval

dateNovember 11, 2022

architect

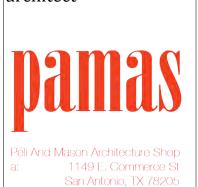


project name

Prado Residence Remodel and Addition

Site Elevations -Main House

drawing number

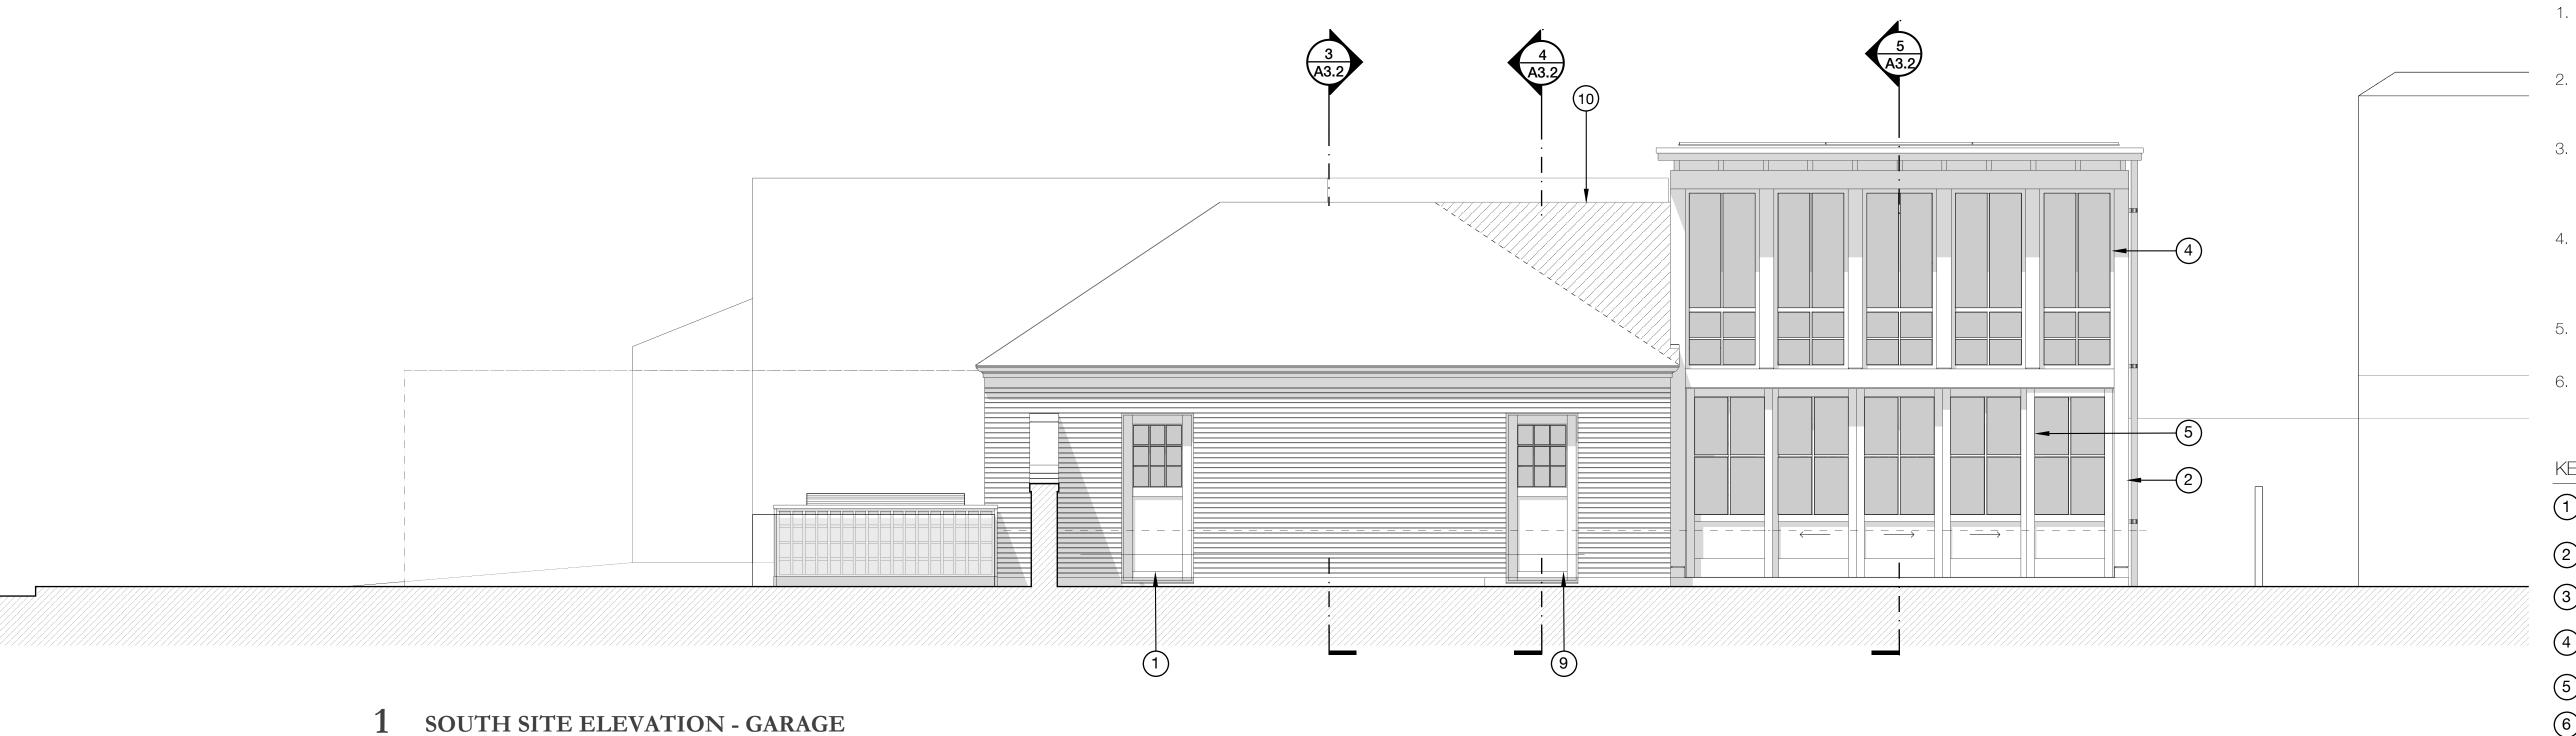


GENERAL NOTES

- 1. GENERAL CONTRACTOR TO NOTIFY ARCHITECT OF ANY CONDITIONS UNCOVERED UPON DEMOLITION
- REFRENCE STRUCTURAL PLANS FOR FRAMING MEMBER SIZES, LOCATIONS AND CONNECTION DETAILS.
- CONTRACTOR TO PROVIDE MATERIAL, FINISH AND PAINT SAMPLES TO OWNER AND ARCHITECT FOR APPROVAL PRIOR TO ORDERING OR FABRICATION
- EXISITING BRICK CLADDED STRUCTURE TO REMAIN. SOILED OR DAMAGED BRICK BE CLEANED AND OR REPAIRED, TYP. UNLESS NOTED OTHERWISE. REFER TO A1.0
- EXISITING DOORS AND WINDOWS TO REMAIN, TYP. UNLESS NOTED OTHERWISE. REFER TO A1.0
- EXISITING GARDEN WALL TO REMAIN, TYP. UNLESS NOTED OTHERWISE. REFER TO A1.0

KEYNOTES

Scale: 1/4"=1'-0"

- 1) EXISTING DOOR TO REMAIN/ REFURBISH TO MATCH
- 2 NEW PAINTED WOOD FRAMING MEMBER
- 3 NEW PAINTED WOOD CLADDING
- 4) NEW WINDOW METAL CLAD
- (5) NEW DOOR METAL CLAD
- NEW SCREENED PORCH PAINTED WOOD SASHES
- 7 NEW AWNING METAL SUPPORT WITH GLASS PANELS
- 8 NEW PHOTOVOLTAIC PANELS

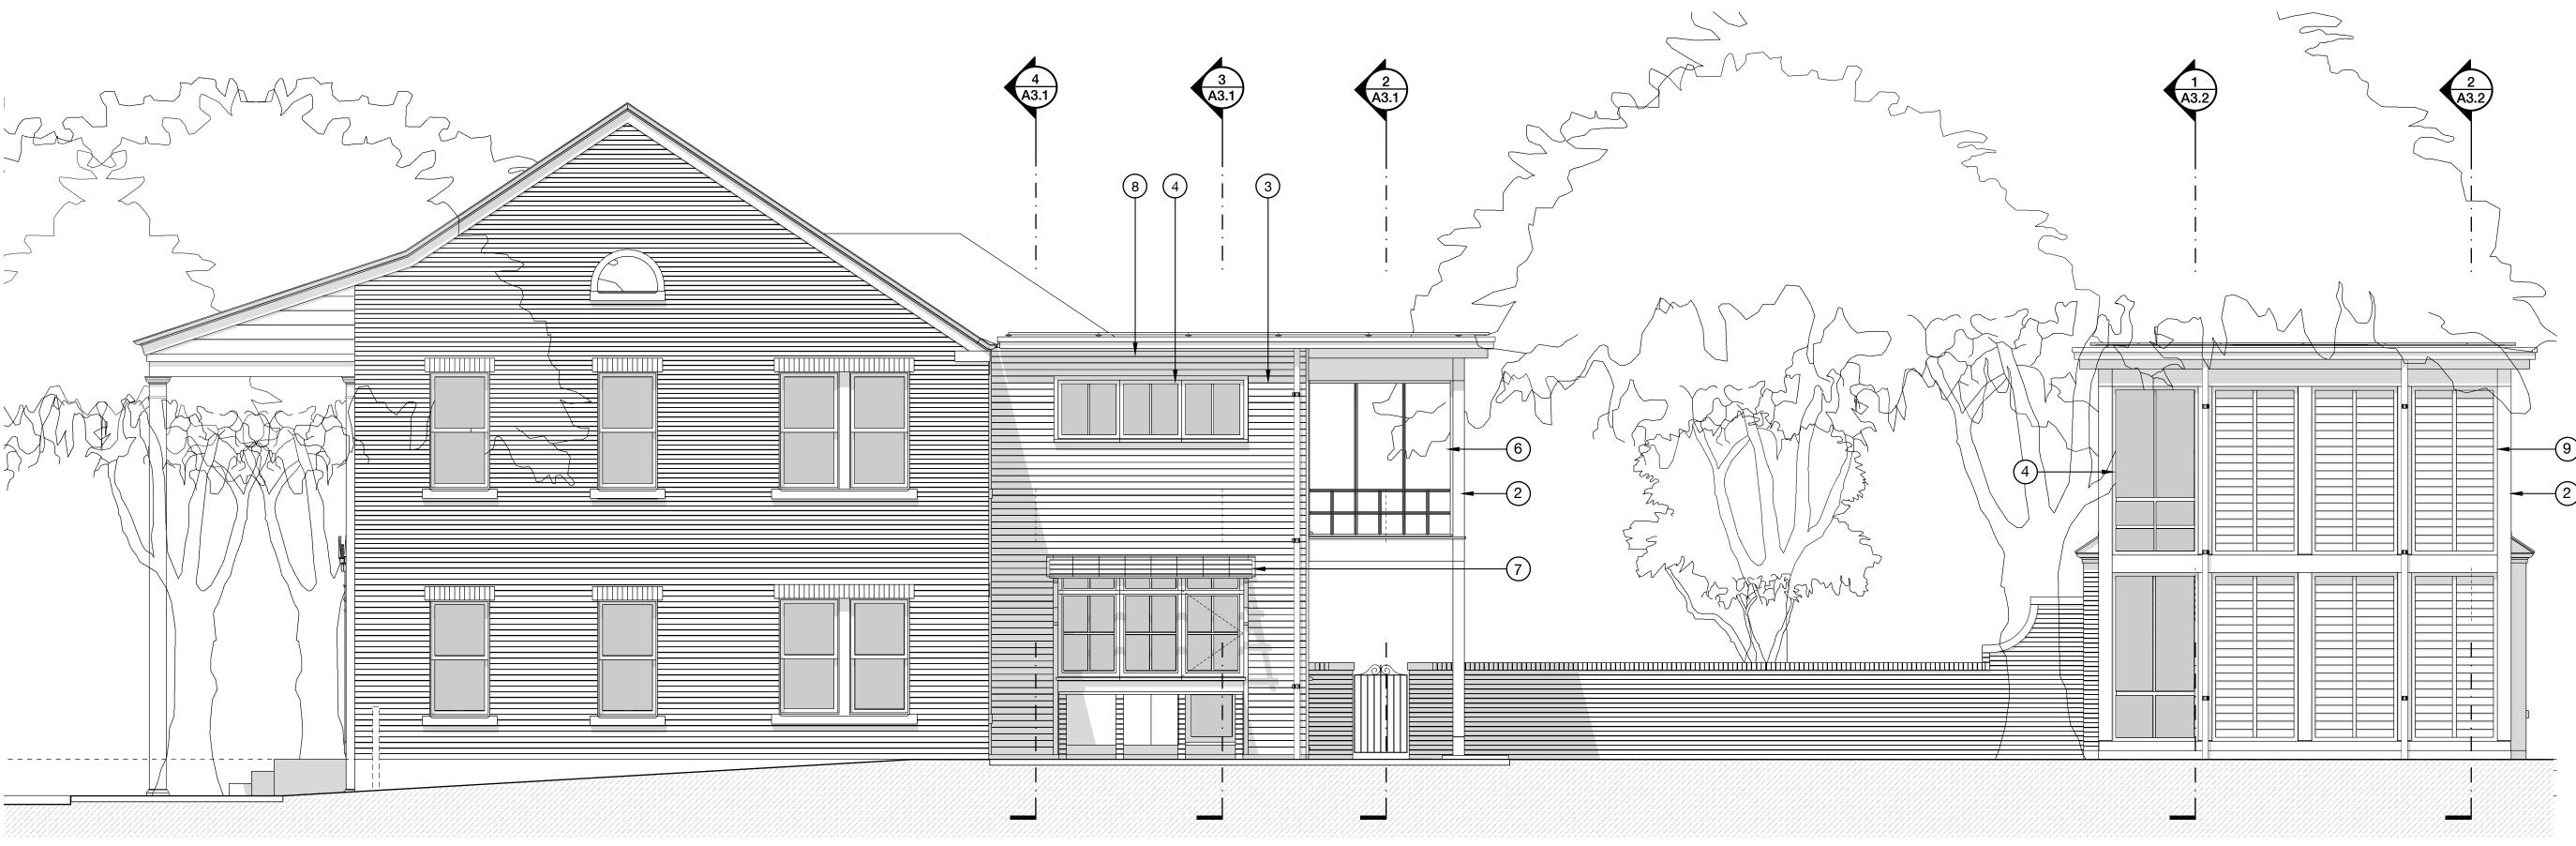

2 EAST SITE ELEVATION

Scale: 1/4"=1'-0"

Not for construction, permitting or

regulatory approval dateNovember 11, 2022

architect



San Antonio, TX 78205

project name

Prado Residence Remodel and Addition 227 W. Gramercy Place, San Antonio, TX 78212

sheet title

revisions


drawing number

NOTES

- 1. EXISITING BRICK CLADDED STRUCTURE TO REMAIN. SOILED OR DAMAGED BRICK BE CLEANED AND OR REPAIRED, TYP. UNLESS NOTED OTHERWISE. REFER TO A1.0
- 2. EXISITING DOORS AND WINDOWS TO REMAIN, TYP. UNLESS NOTED OTHERWISE. REFER TO
- 3. EXISITING GARDEN WALL TO REMAIN, TYP. UNLESS NOTED OTHERWISE. REFER TO A1.0

KEYNOTES

- 1) EXISTING DOOR/ WINDOW TO REMAIN/ REFURBISH TO MATCH
- 2 NEW EXPOSED CONCRETE FOUNDATION
- 3 NEW PAINTED WOOD FRAMING MEMBER
- 4 NEW WINDOW METAL CLAD
- 5 NEW FIXED PANEL PAINTED WOOD
- 6 NEW ROOF TO MATCH EXISTING
- 7 EXISTING SKYLIGHT TO BE RELOCATED

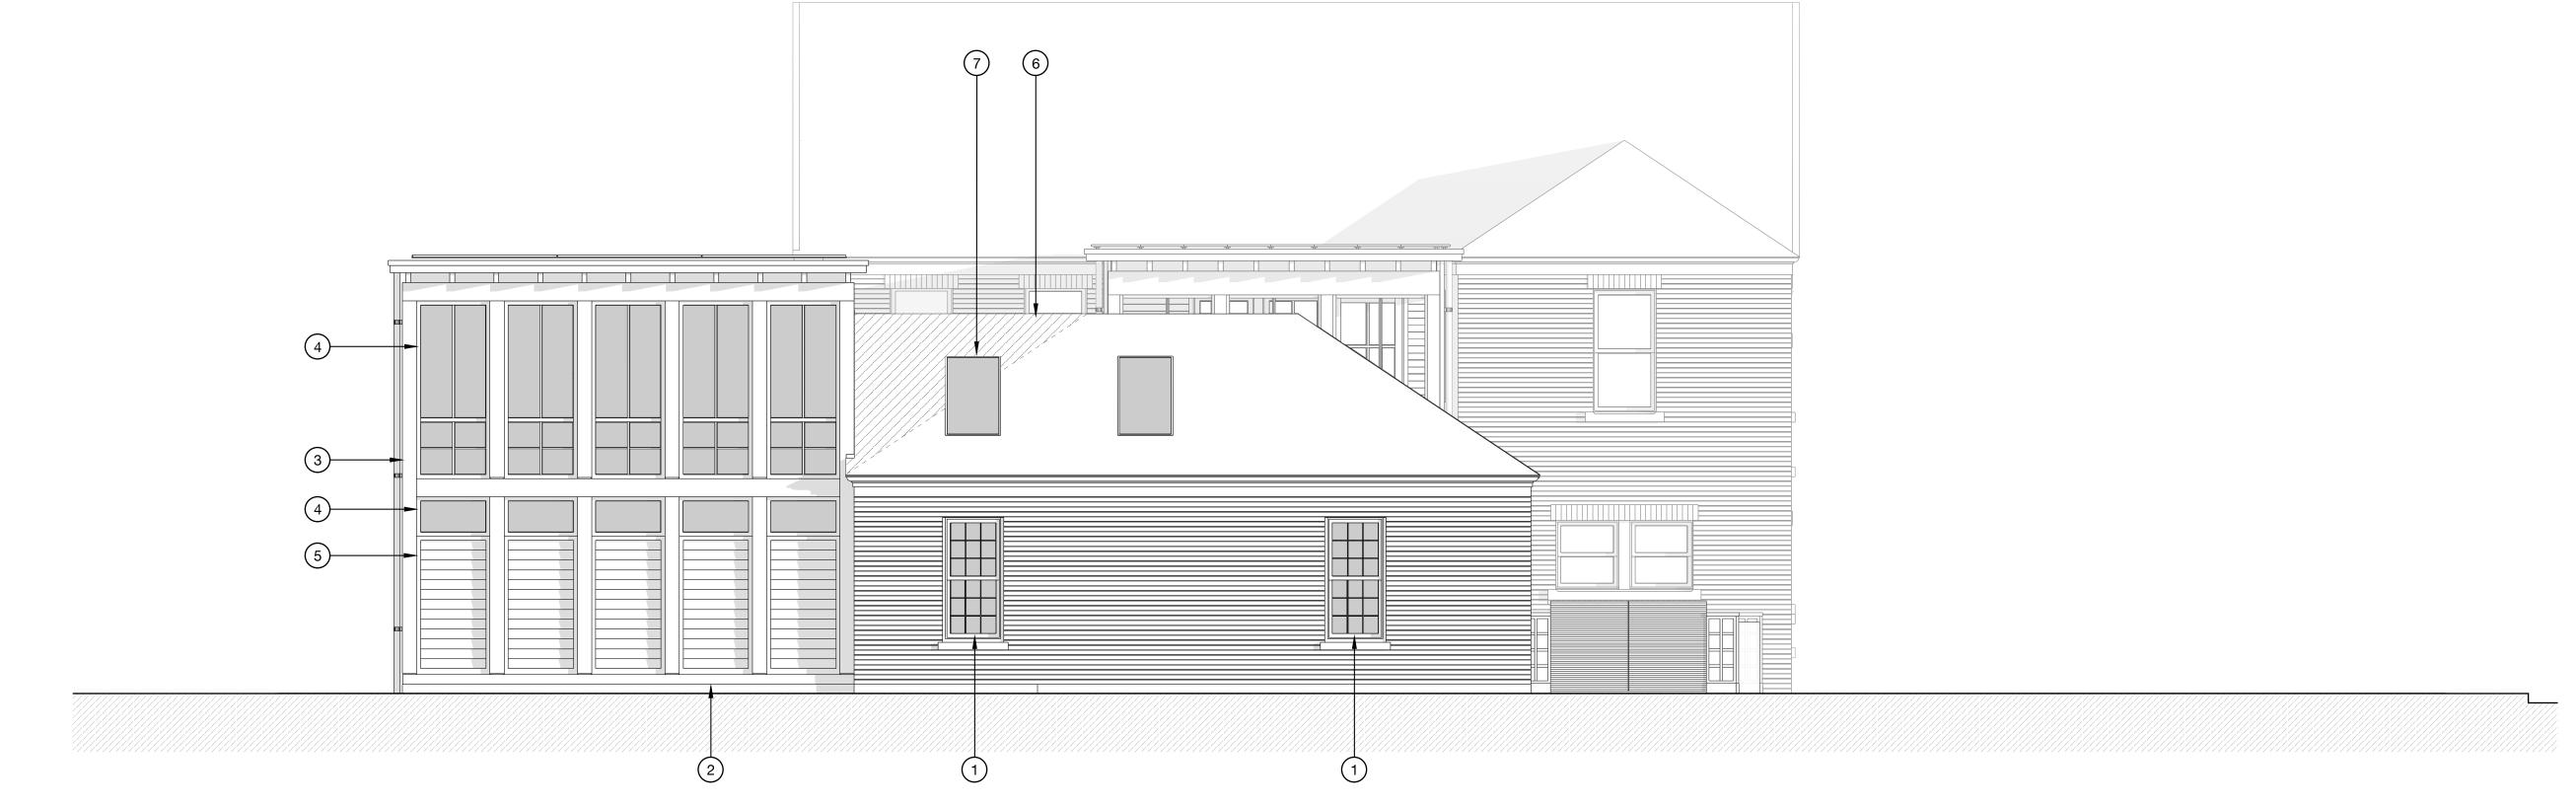

NORTH SITE ELEVATION - GARAGE

Scale: 1/4"=1'-0"

Not for construction, permitting or

dateNovember 11, 2022

Péli And Mason Architecture Shop
a: 1149 E. Commerce St
San Antonio, TX 78205

regulatory approval

project name

Prado Residence
Remodel and Addition
227 W. Gramercy Place,
San Antonio, TX 78212

sheet title


site Elevations - Garage

phase CD

revisions


drawing number


A2.3

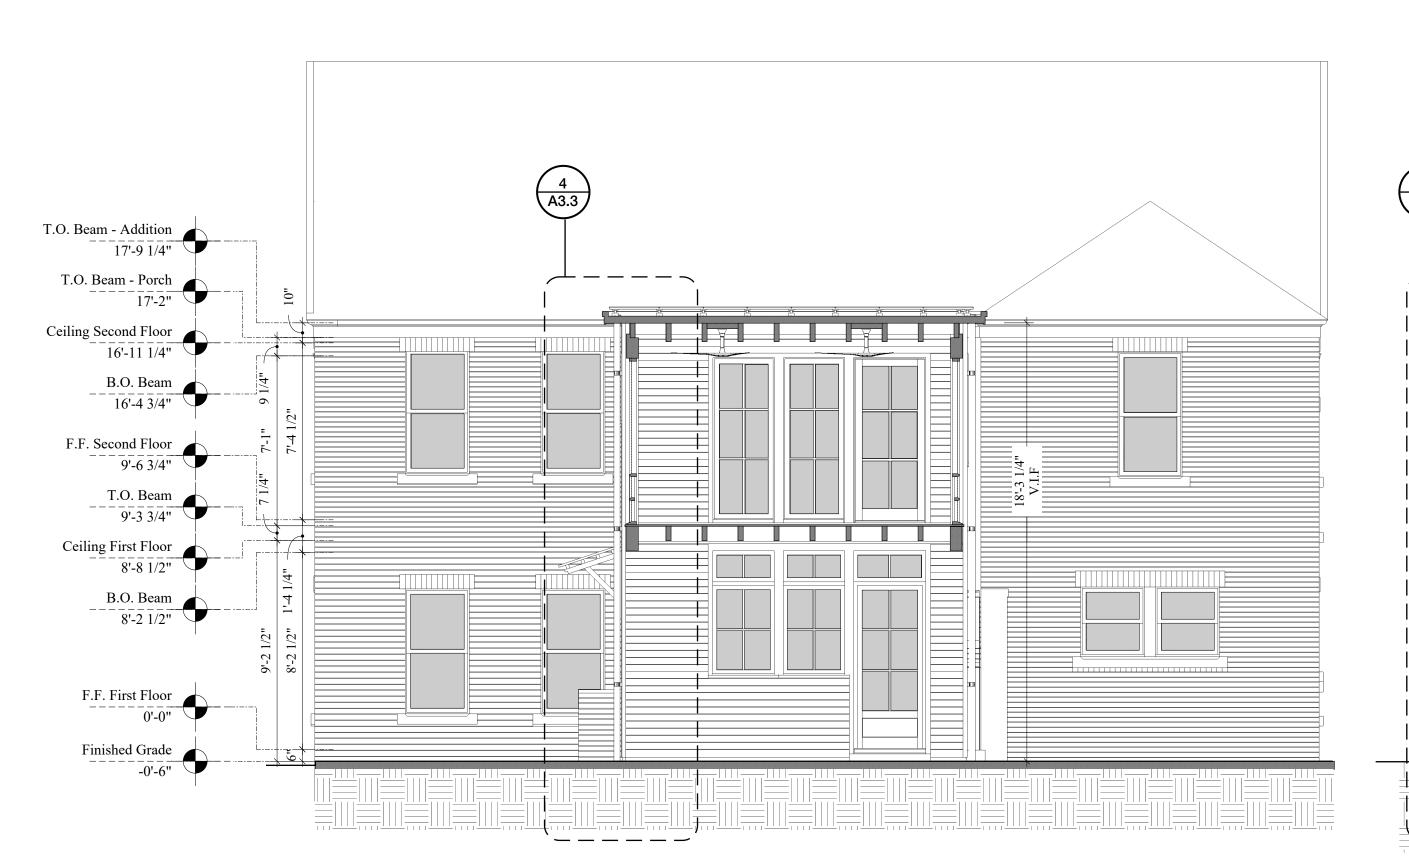

BUILDING SECTION - MAIN HOUSE

Scale: 1/4"=1'-0"

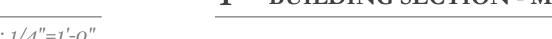

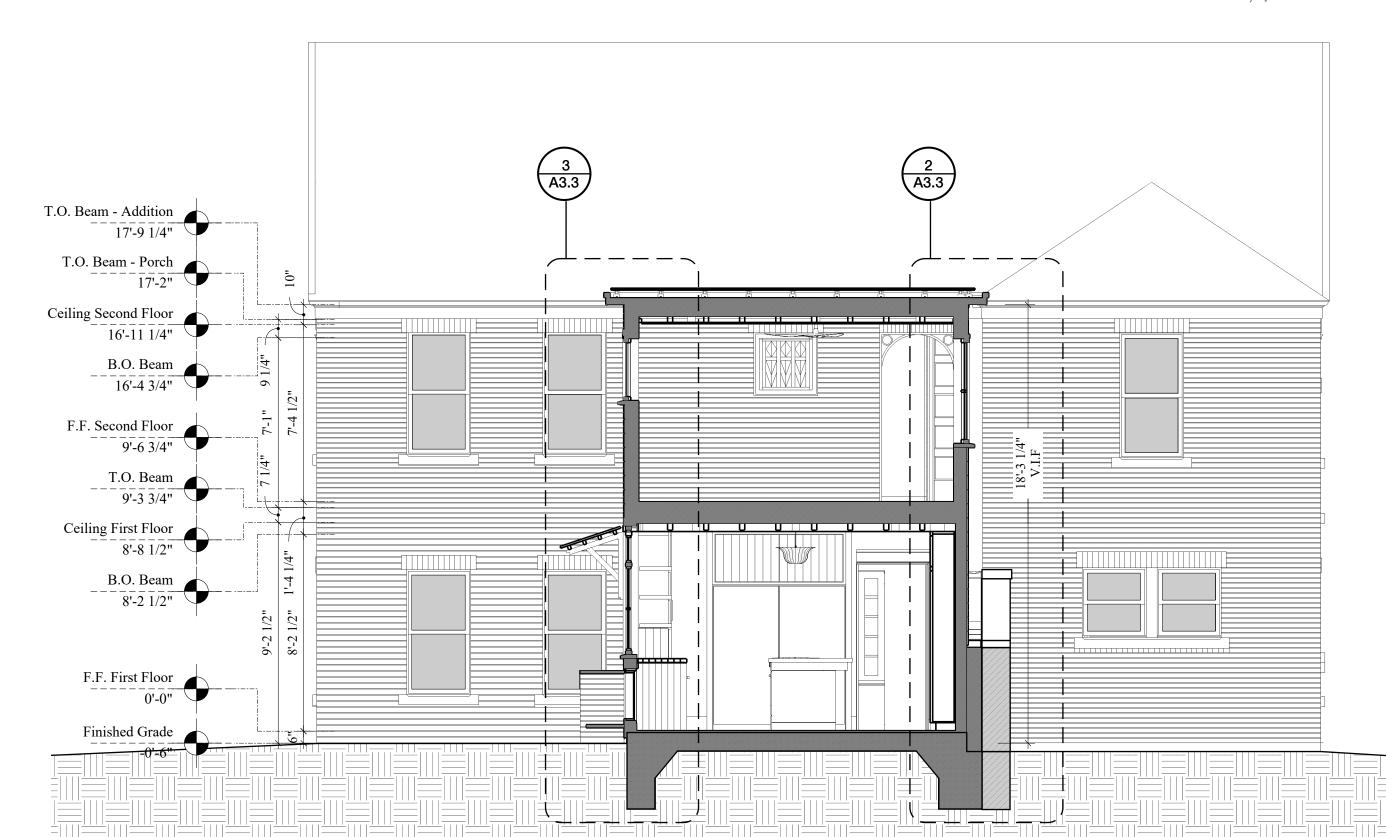

BUILDING SECTION - MAIN HOUSE

BUILDING SECTION - MAIN HOUSE

X A3.X X A3.X X A3.X

> sheet title Main Sections House Building revisions

Not for

construction,

permitting or

regulatory approval

dateNovember 11, 2022

149 E. Commerce St, Suite 200 San Antonio, TX 78205

project name

Prado Residence Remodel and Addition

227 W. Gramercy Place, San Antonio, TX 78212

architect

drawing number


11/11/2022

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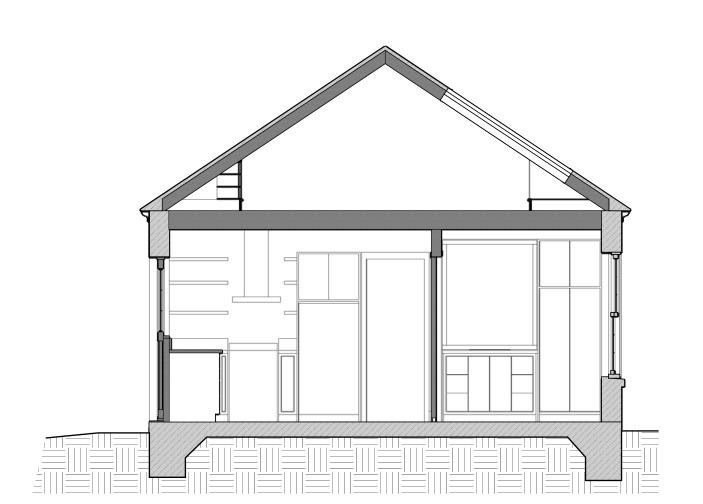
Scale: 1/4"=1'-0"

BUILDING SECTION - MAIN HOUSE Scale: 1/4"=1'-0"


1 A3.3

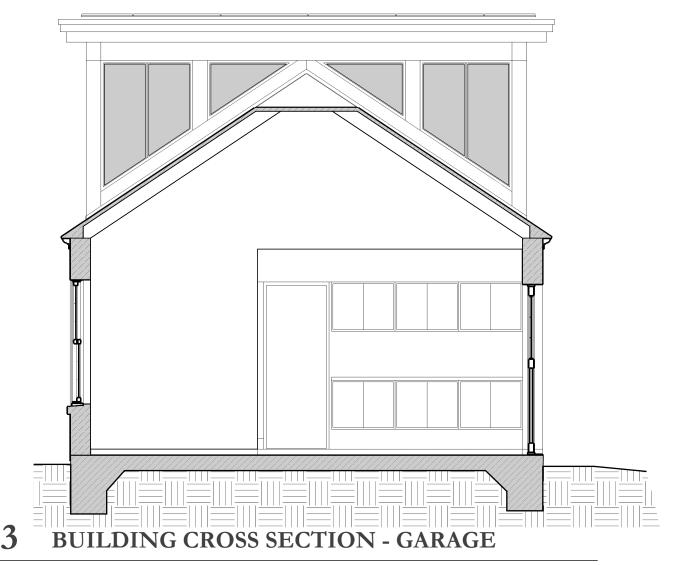



Scale: 1/4"=1'-0"



4 BUILDING CROSS SECTION - KITCHENETTE AND BATH

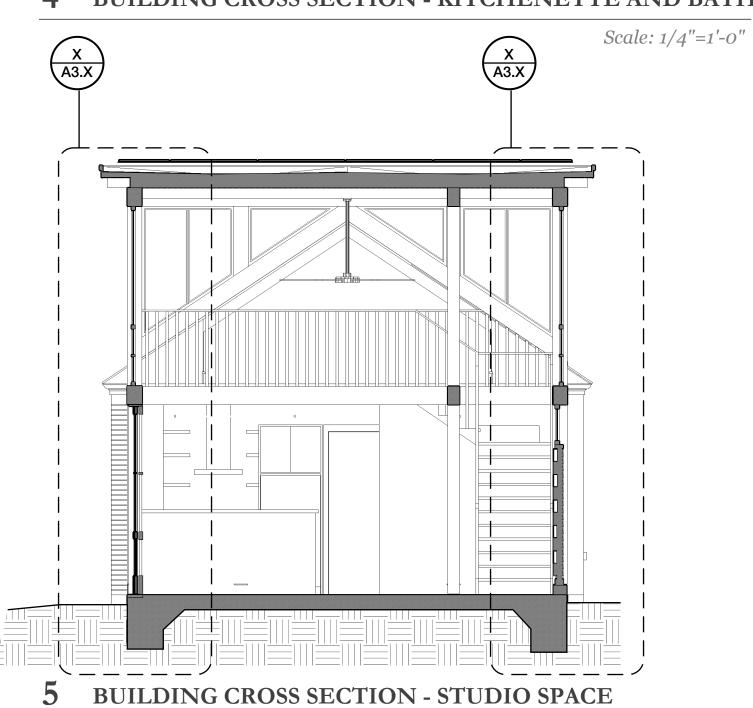

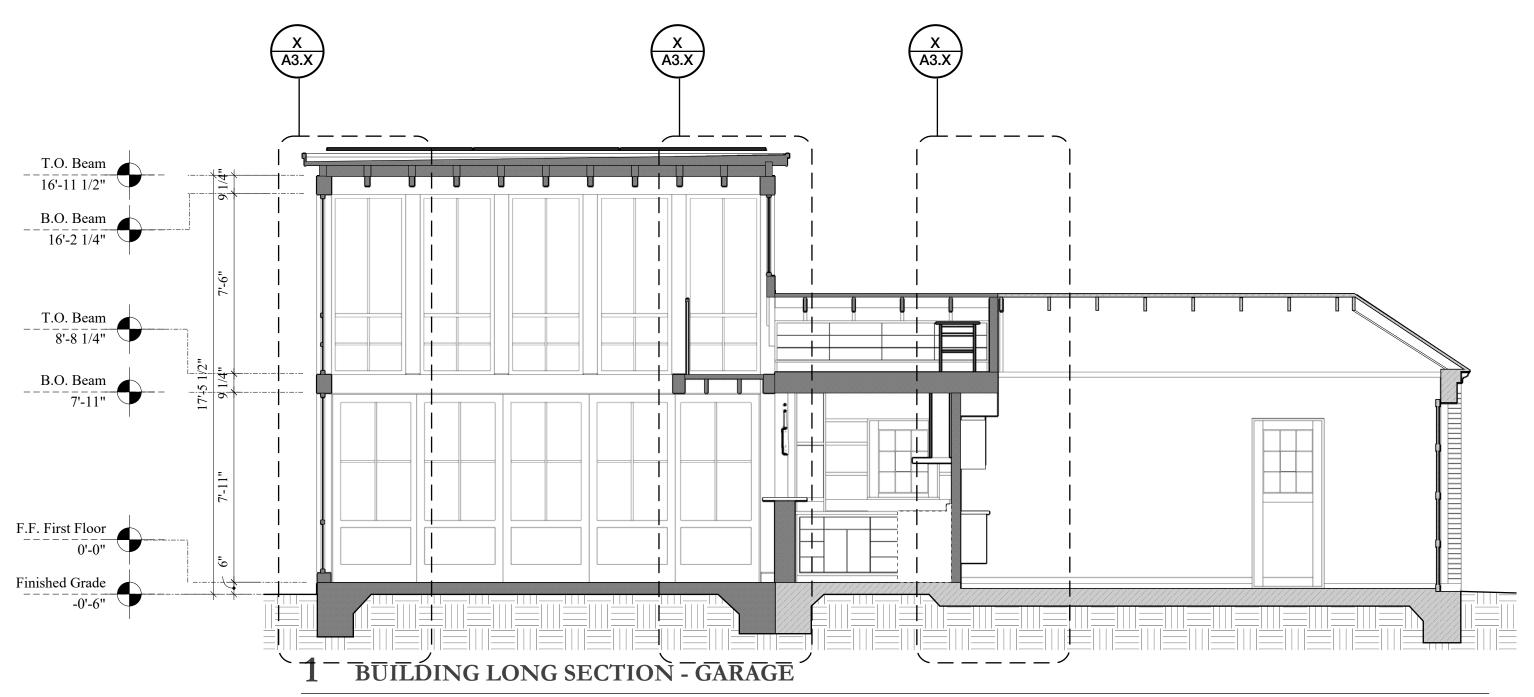

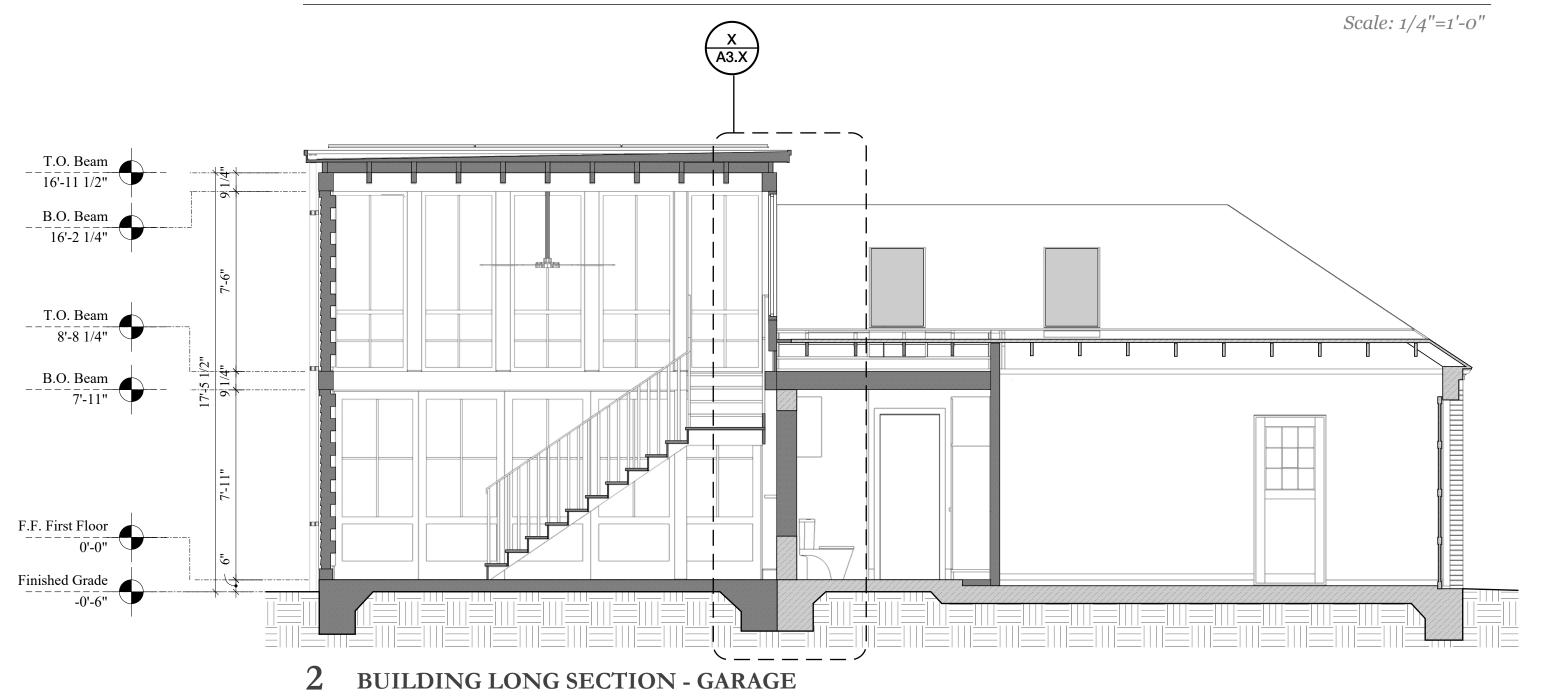

seal

Not for construction, permitting or regulatory approval

dateNovember 11, 2022

1.1.



project name

Prado Residence
Remodel and Addition
227 W. Gramercy Place,
San Antonio, TX 78212

sheet title

Building Sections - Garage

phase CD

revisions


drawing number

A3.2

11/11/2022

Scale: 1/4"=1'-0"

Scale: 1/4"=1'-0"

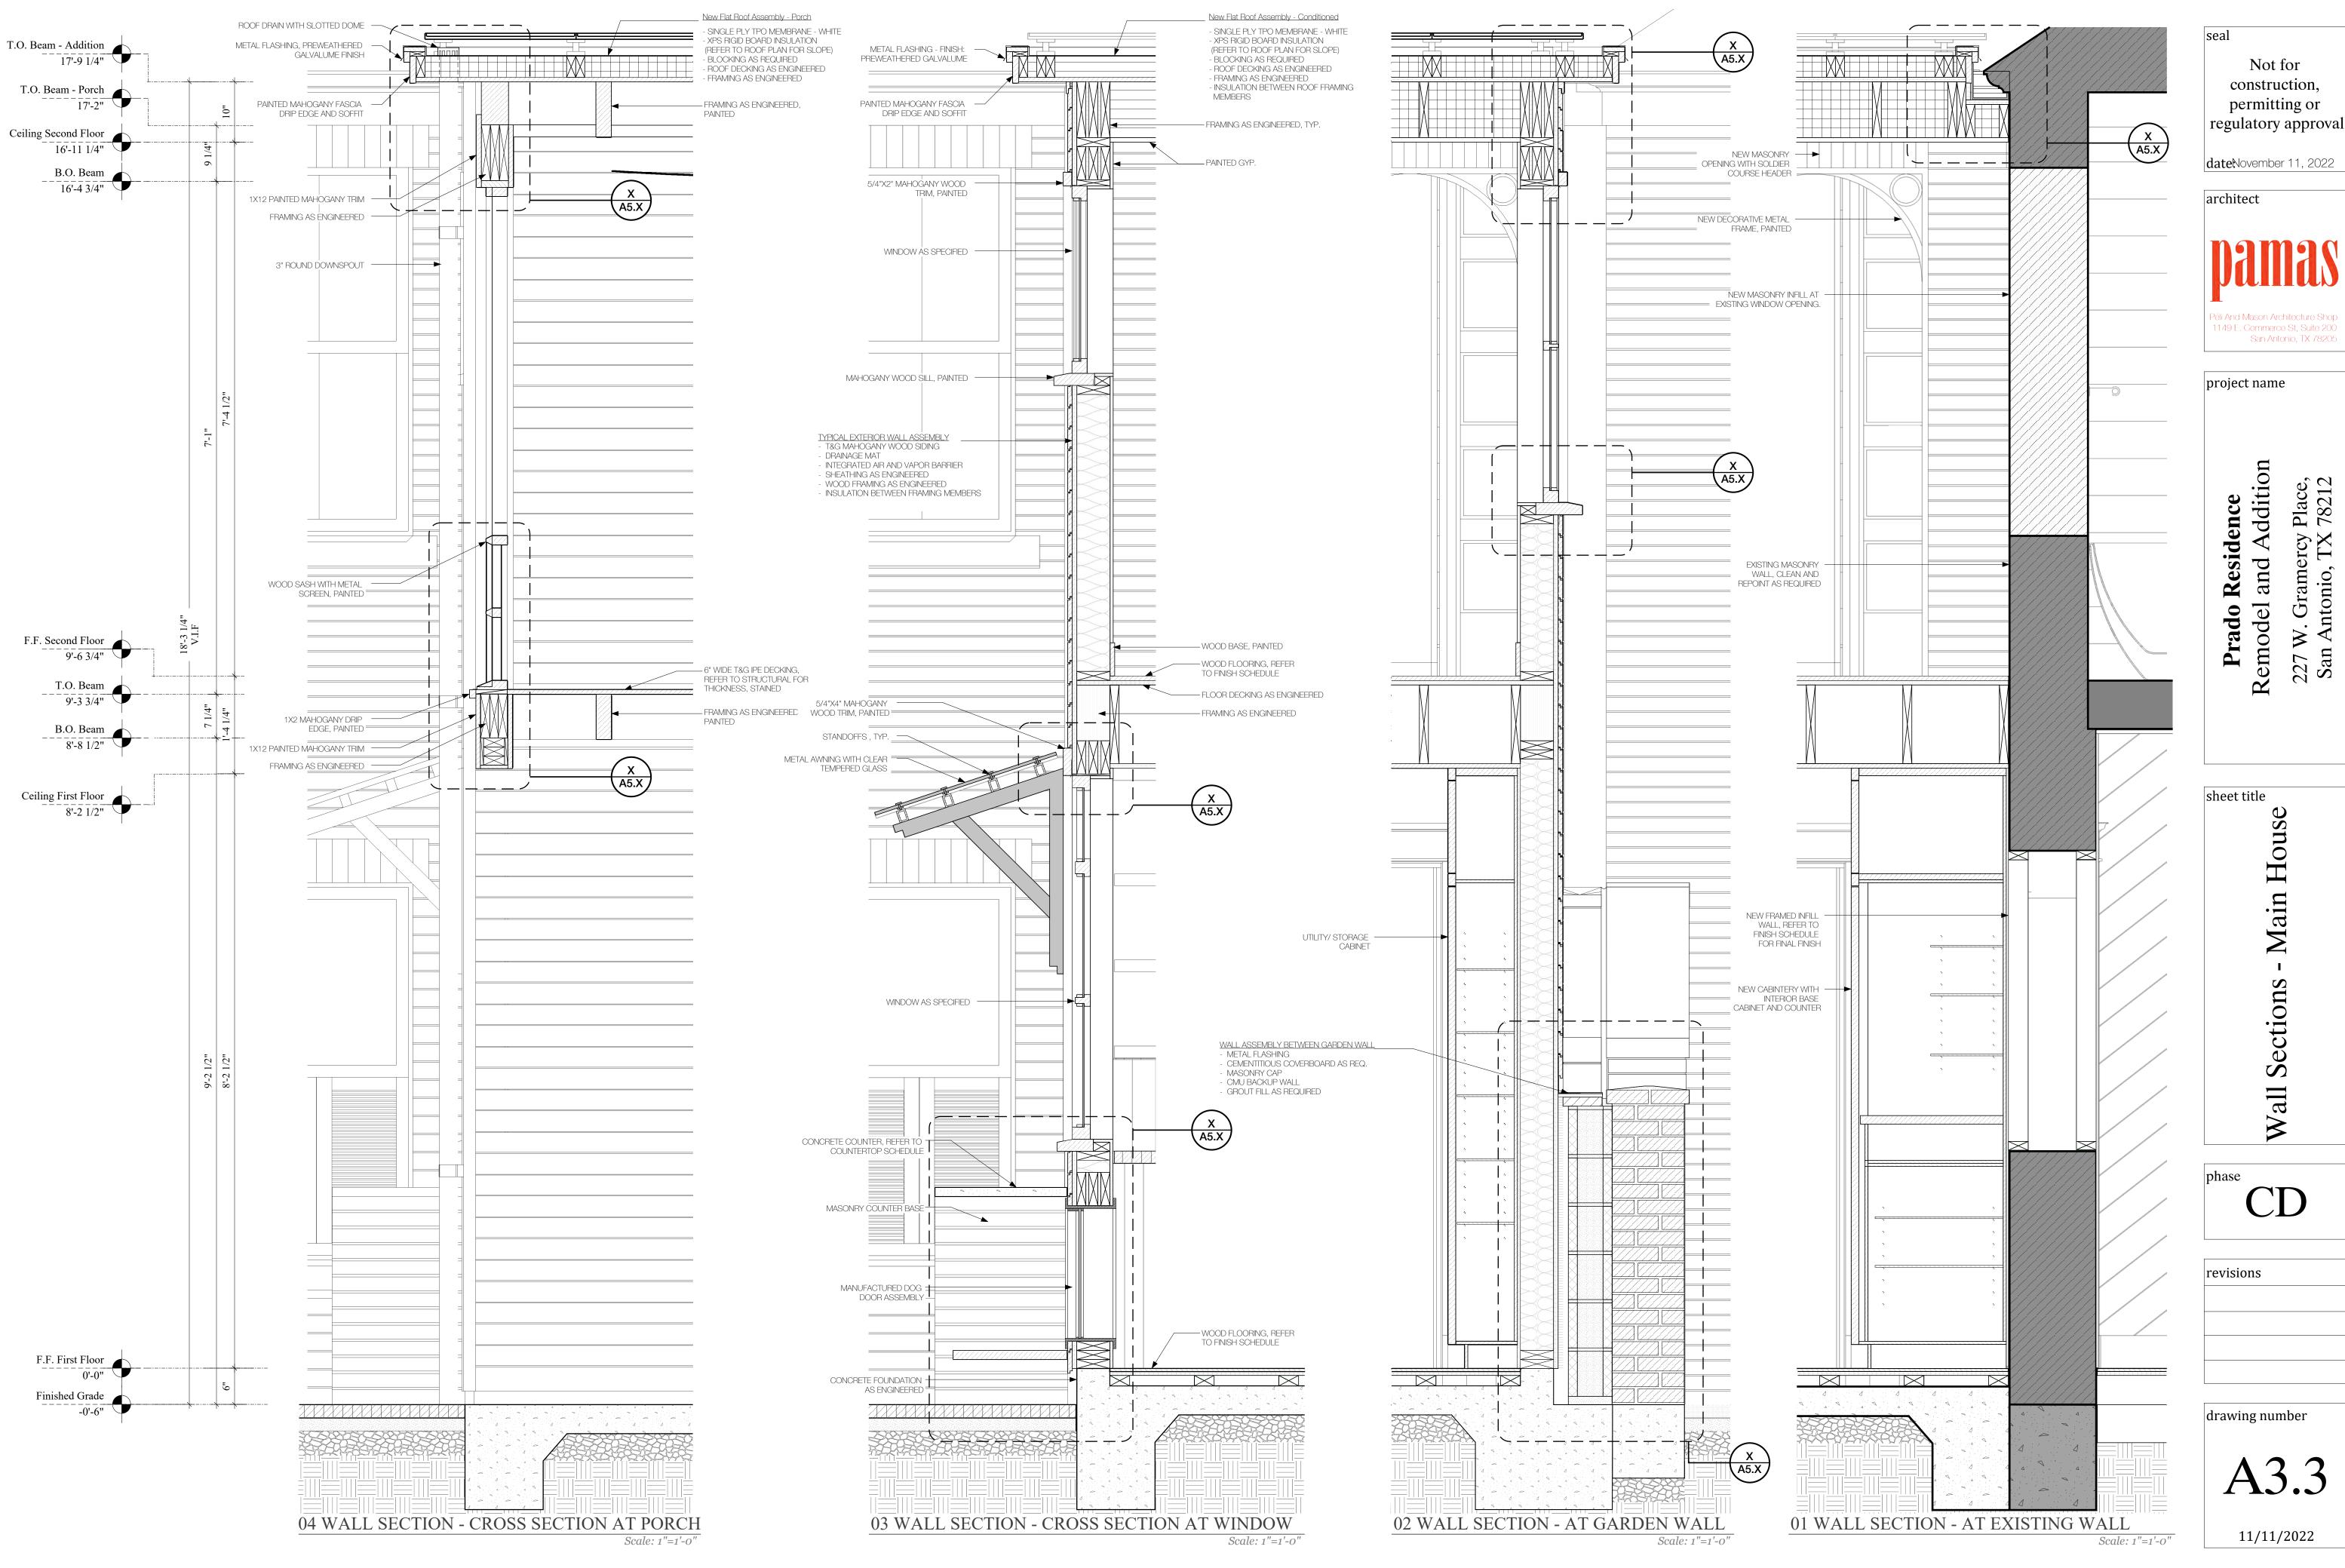





KEYNOTES

LUEDERS LIMESTONE CAP WITH 1/4" PER FOOT SLOPE VENEER

EXISTING GUTTER TO BE MODIFIED AND CONNECTED TO NEW DOWNSPOUT LOCATIONS

(7.1) METAL FLASHING OVER 1X MAHOGANY SILL FINISH: PAINTGRIP

SINGLE PLY TPO WATERPROOFING,
COLOR: WHITE
OVER MANUFACTURER'S COVER BOARD
AND XPS RIGID INSULATION

4" ROUND DOWNSPOUT WITH AREA DRAIN. FINISH: PAINTRGRIP + EXT PAINT 01

TEMPERED GLASS CANOPY ON METAL STANDOFFS.

GENERAL NOTES

1. GENERAL CONTRACTOR TO NOTIFY ARCHITECT OF ANY CONDITIONS UNCOVERED UPON DEMOLITION

2. GENERAL CONTRACTOR TO VERIFY FIELD CONDITIONS PRIOR TO DETERMINING FINAL ROOF SLOPES AND DETAIL CONNECTIONS

3. REFRENCE STRUCTURAL PLANS FOR STAIRCAL FRAMING MEMBER SIZES, LOCATIONS AND CONNECTION DETAILS.

4. CONTRACTOR TO PROVIDE
MATERIAL, FINISH AND PAINT SAMPLES
TO OWNER AND ARCHITECT FOR
APPROVAL PRIOR TO ORDERING OR
FABRICATION

phase CD

revisions

drawing number

A4.1

11/11/2022

Scale: 1/2"=1'-0"

7.4

ROOF PLAN - AT MAIN HOUSE ADDITION

/2"=1'-0"

1 FLOOR PLAN - FIRST FLOOR PORCH

Scale: 1/2"=1'-0"




SOUTH ELEVATION - GARAGE ADDITION





EAST ELEVATION - GARAGE ADDITION

Scale: 1/2"=1'-0"

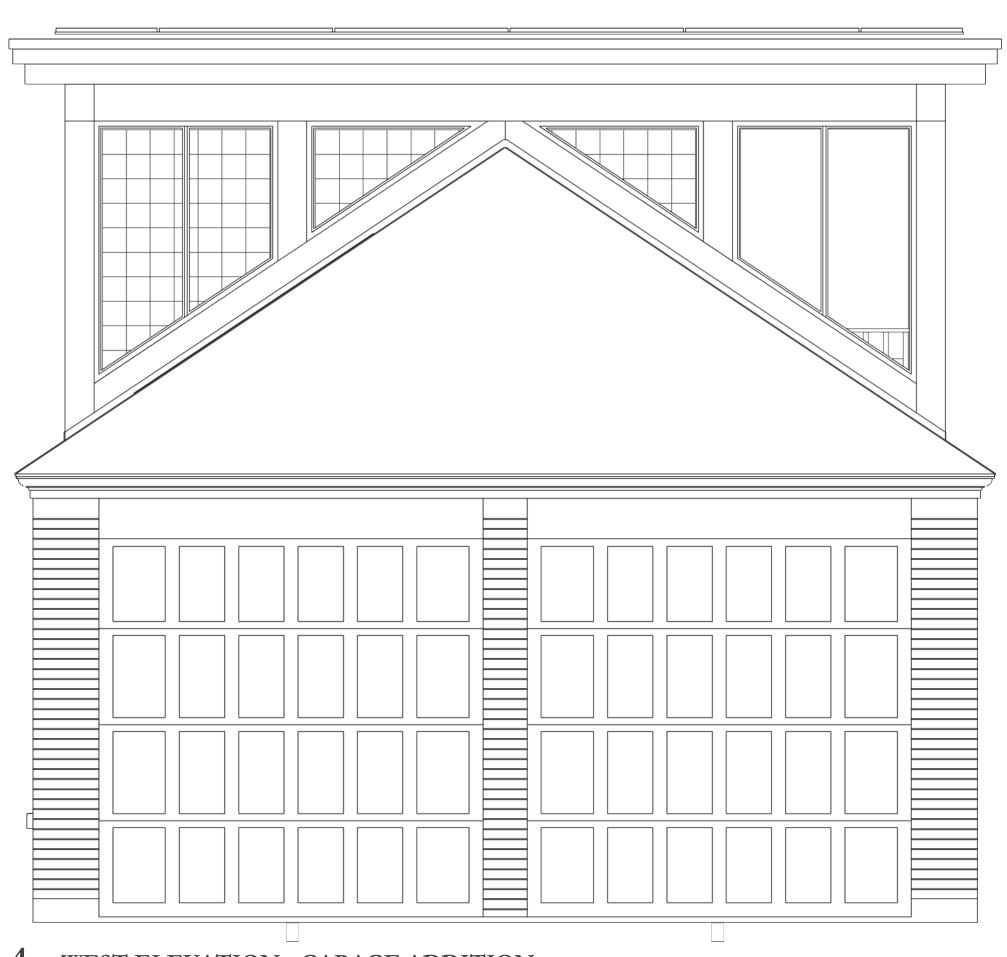

WEST ELEVATION - GARAGE ADDITION

Scale: 1/2"=1'-0"

Not for construction, permitting or regulatory approval dateNovember 11, 2022

architect



project name

Prado Residence Remodel and Addition

sheet title


ns and Details Addition Enlarged Plans a - Garage A

revisions

drawing number

11/11/2022

Scale: 1/2"=1'-0"

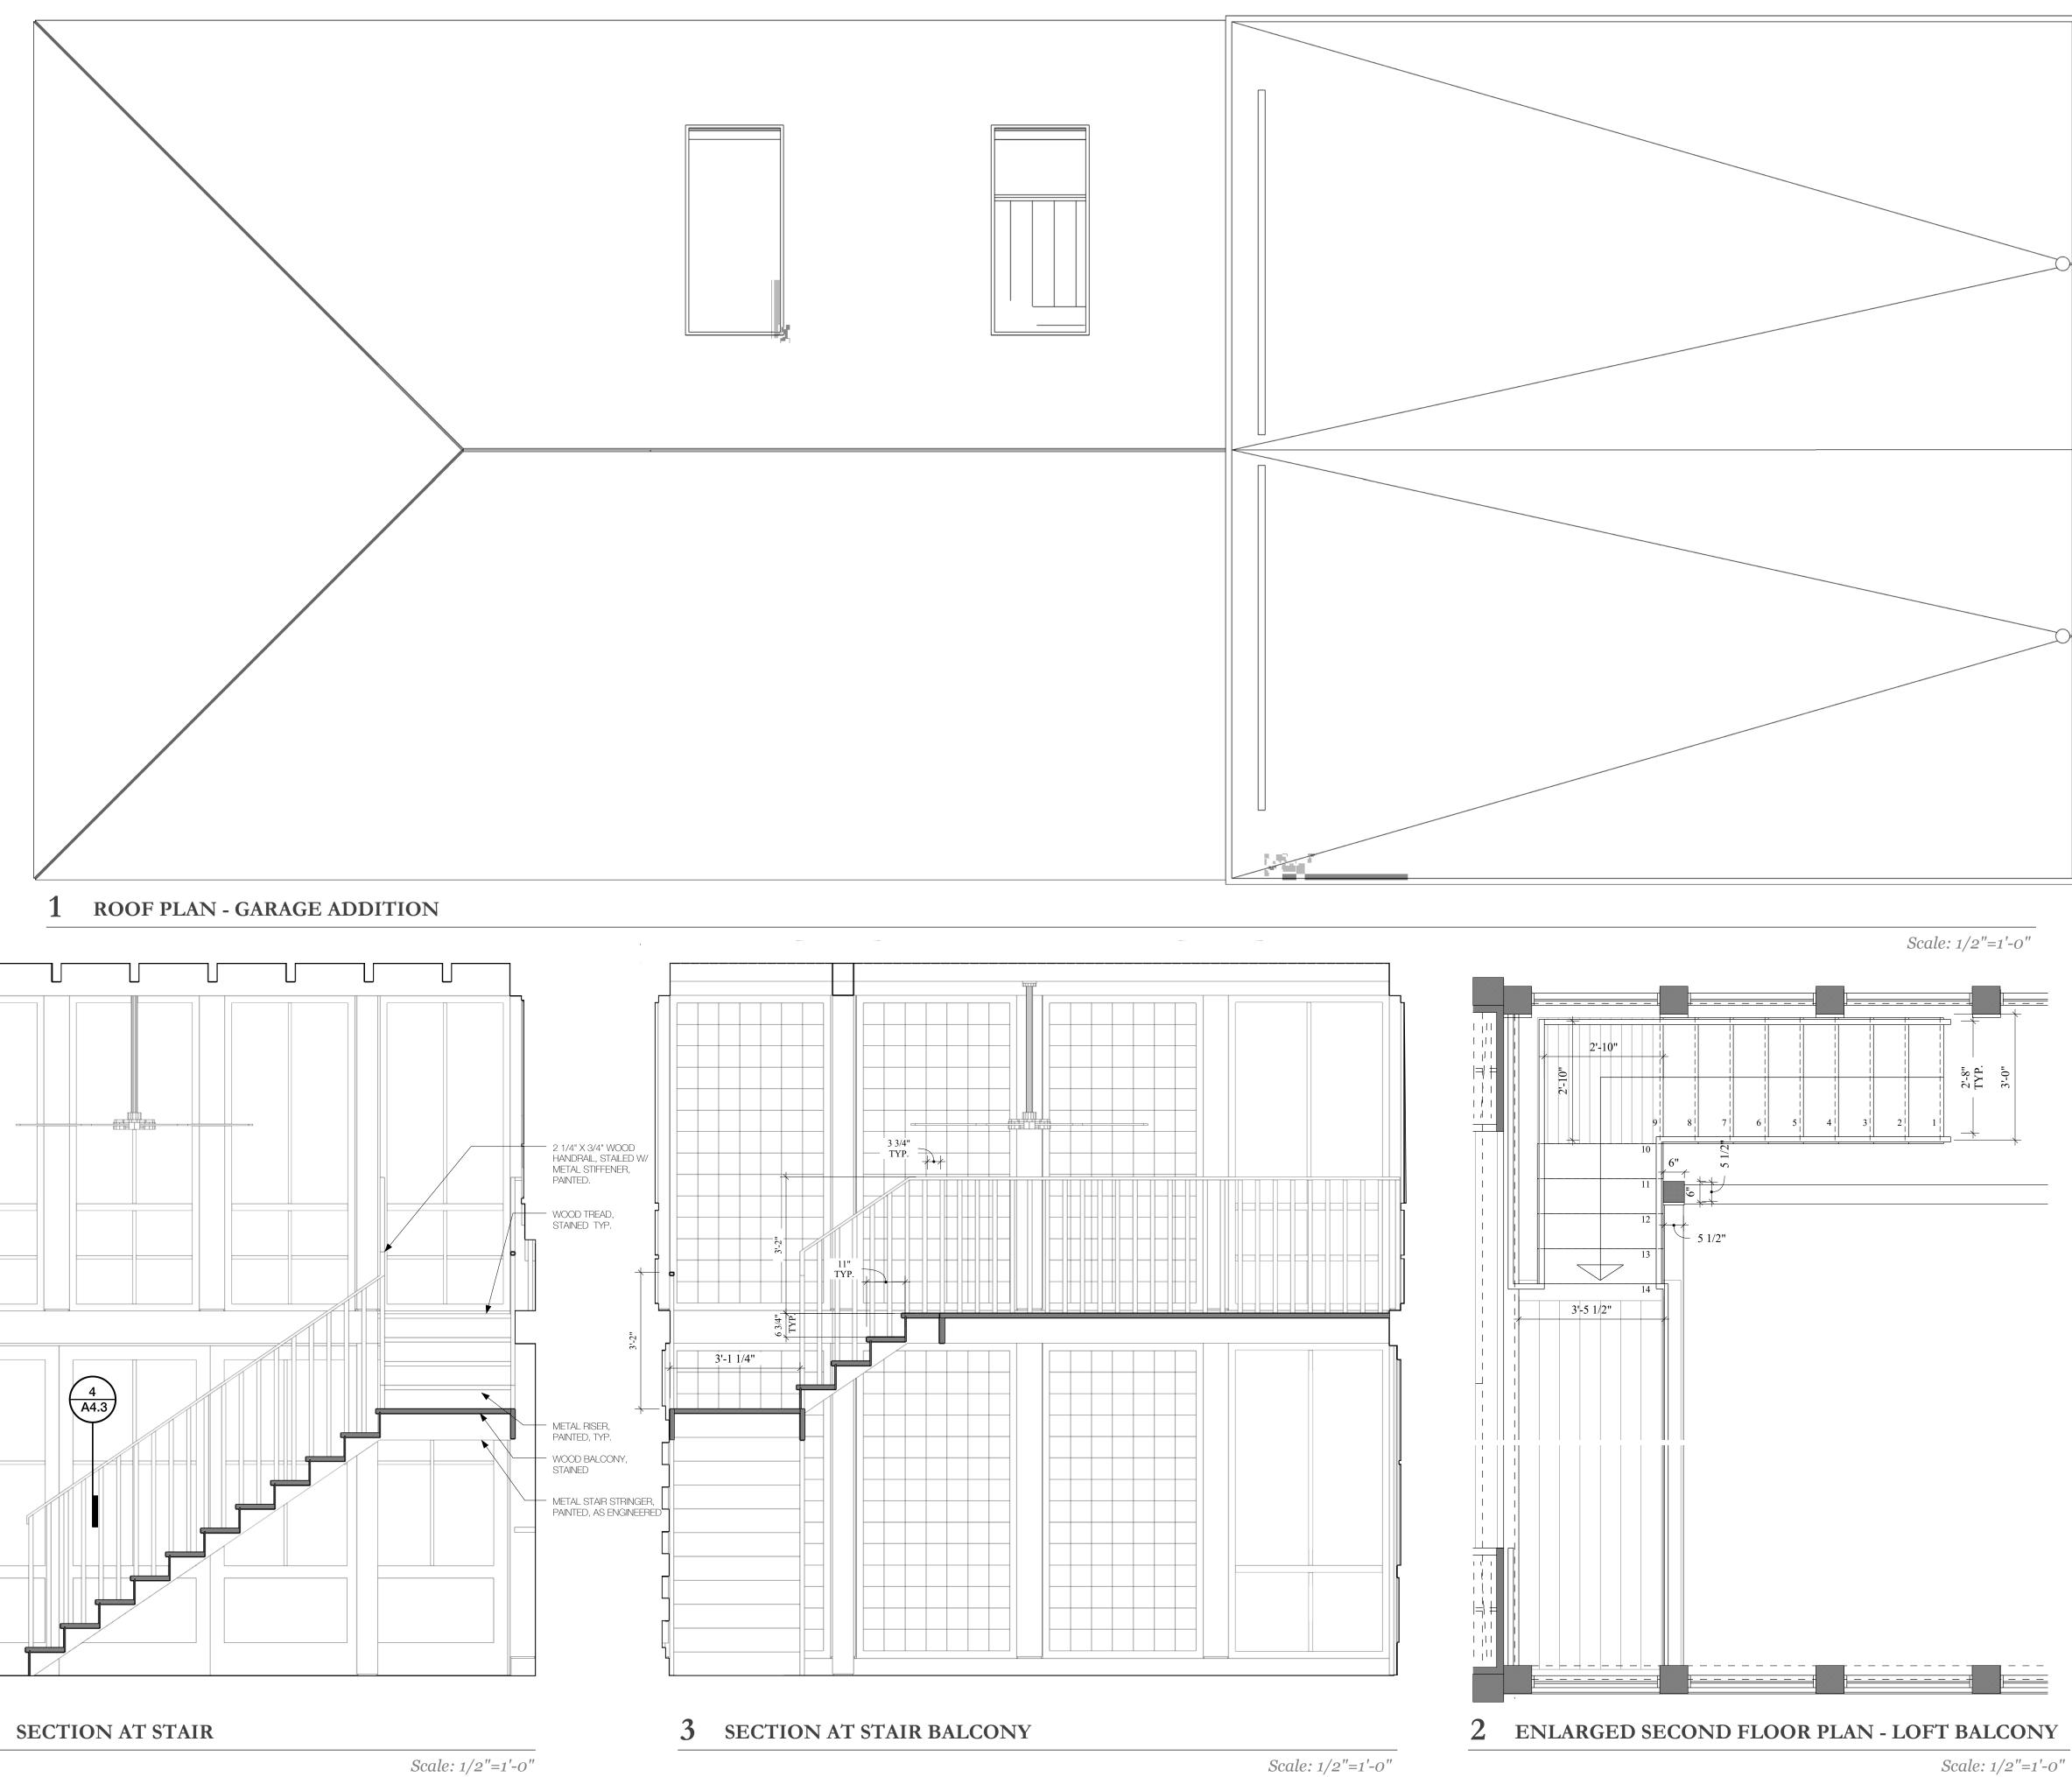

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dateNovember 11, 2022

architect 1149 E. Commerce St, Suite 200 San Antonio, TX 78205

project name

Prado Residence Remodel and Addition 227 W. Gramercy Place, San Antonio, TX 78212

sheet title

Details Stairs Enlarged Plans and - Garage Addition

revisions

drawing number

11/11/2022

Scale: 1/2"=1'-0"

GENERAL NOTES

- 1. GENERAL CONTRACTOR TO NOTIFY ARCHITECT OF ANY UNKNOWN CONDITIONS UNCOVERED UPON DEMOLITION
- 2. CONTRACTOR TO PROVIDE MATERIAL, FINISH AND PAINT SAMPLES TO OWNER AND ARCHITECT FOR APPROVAL PRIOR TO ORDERING OR FABRICATION
- 3. GENERAL CONTRACTOR TO PATCH AND REPAIR AND REFINISH EXISTING WOOD FLOORING AS NECESSARY
- 4. GENERAL CONTRACTOR TO PATCH AND REPAIR AND REFINISH EXISTING GYPSUM CEILING AS NECESSARY
- 5. GENERAL CONTRACTOR TO PATCH AND REPAIR AND REFINISH EXISTING PLASTER WALLS AND CEILING AS NECESSARY / SPECIFIED

<u>KITCHEN</u> - MATERIAL: - SIZE: - THICKNESS: - FINISH: - SOURCE: - MATERIAL: - SIZE: - THICKNESS: - FINISH: - SOURCE: MASTER BATH - MATERIAL: - SIZE: - THICKNESS: - FINISH: - SOURCE: **BATH 02**

- MATERIAL: - SIZE:

- THICKNESS: - FINISH:
- SOURCE:
- STUDIO KITCHEN - MATERIAL:
 - SIZE: - THICKNESS:
 - FINISH:
 - SOURCE:
- STUDIO BATH
 - MATERIAL: -
 - SIZE: - THICKNESS:
 - FINISH: - SOURCE:
- **5 COUNTERTOP SCHEDULE**

Scale: N/A

CONCRETE EXISTING - PREP: CLEAN - FINISH: SEAL

CONCRETE 01

- PREP: TROWELED FINISH - FINISH: SEAL WITH CLEAR SATIN SEALER

5 FLOORING FINISH

4 TILE SCHEDULE Scale: N/A

TILE 01

TILE 02

- PORCELAIN TILE

- MANUFACTURER: AMERICA OLEAN

- GROUT: 1/8", LATICRETE PLATINUM

- SEALER: PER MANUFACTURER'S RECOMMENDATION

- SIZE: 3" X 6" (LAID IN RUNNING BOND PATTERN)

- GROUT: 1/8", LATICRETE PLATINUM

- SEALER: PER MANUFACTURER'S RECOMMENDATION

- PRODUCT NAME: THEORETICAL

- COLOR: FUNDAMENTAL GRAY

- SIZE: 24"x12" (3/8" THICKNESS)

- PORCELAIN TILE - MANUFACTURER: AMERICAN OLEAN - PRODUCT NAME: THEORETICAL - COLOR: FUNDAMENTAL GRAY - SIZE: 2"x2" MOSAIC (1/4" THICKNESS) - SEALER: PER MANUFACTURER'S RECOMMENDATION - GROUT: 1/8", LATICRETE PLATINUM TILE 03 - MASTER BATH SHOWER FLOOR - GLAZED PORCELAIN TILE - MANUFACTURER: AMERICAN OLEAN - PRODUCT NAME: WHITE SUBWAY TILE

Scale: N/A

EXISTING WOOD FLOOR - SAND AND REFINISH. - FINISH: BONA NATURALSEAL, BONA TRAFFIC FINISH, SATIN SHEEN,

WOOD 01

- MATCH EXISTING WOOD FLOOR - SPECIES: TBD, T+G RANDOM LENGTH PLANK FLOORING,

WITH RANDON JOINT LAYOUT - SAND AND FINISH.

- FINISH: BONA NATURALSEAL, BONA TRAFFIC FINISH, SATIN SHEEN,

WOOD 02

- IPE 2X6 T&G DECKING, CONFIRM SIZES WITH ENGINEERING - FINISH: STAIN TO MATCH INTERIOR FLOOR

3 WOOD FLOOR SCHEDULE 2 PAINT & FINISH SCHEDULE

Scale: N/A

Existing NEW WOOD FLOOR TO MATCH Existing Existing NEW WOOD FLOOR TO MATCH Existing EXISTING Existing NEW WOOD FLOOR TO MATCH Existing EXISTING
NEW WOOD FLOOR TO MATCH Match Exsiting 7'-11" 7'-11" 16'-11 1/2 Existing Existing Existing Existing Existing Existing NEW WOOD FLOOR TO MATCH 7'-4 1/2 EXISTING
NEW WOOD FLOOR TO MATCH Existing EXISTING 7'-10 1/4' 7'-9"

REMARKS

REFER TO A1.1 and A1.2 FLOOR PLAND FOR ADDITIONAL INFORMATION REGARDING OPENING HEIGHTS, MATERIAL TRANSITIONS, THRESHOLDS ETC.

WALL

1 ROOM FINISH SCHEDULE

ROOM

LEVEL 1 - Main House

LIVING ROOM

DINING ROOM

POWDER

PANTRY

OFFICE

LEVEL 1 - Garage

KITCHEN

GARAGE

KITCHEN

STUDIO

STAIRS + STAIR HALL

FAMILY ROOM

BEDROOM 2

BEDROOM 3

MASTER BATH

MASTER BEDROOM

MASTER CLOSET

STAIRS + LANDING

BALCONY

LEVEL 2 - Garage

BATH 2

LEVEL 2 - Main House

SUNROOM

FLOOR

Scale: N/A

Scale: N/A

INTERIOR

PAINT 01

DOOR AND

WINDOW TRIM

CEILING

BASE TRIM

- LATEX PAINT ON GYPSUM BOARD / STUCCO - COLOR: BM WHITE CLOUD OC-130

- SHEEN: MATTE

PAINT 02

- LATEX PAINT ON GYPSUM BOARD / STUCCO - COLOR: BM SIMPLY WHITE OC-117 - SHEEN: MATTE

PAINT WO1

- LATEX PAINT ON WOOD

- COLOR: BM WHITE CLOUD OC-130

- SHEEN: SATIN

PAINT W02

- LATEX PAINT ON WOOD - COLOR: BM IMPERIAL GRAY 1571

- SHEEN: SATIN

EXTERIOR EXTERIOR PAINT 02

- LATEX PAINT ON WOOD - COLOR: BM INTRIGUE 1580 - SHEEN: SATIN

Not for construction. permitting or regulatory approval

dateNovember 11, 2022

architect 1149 E. Commerce St, Suite 200 San Antonio, TX 78205

project name

Residence I and Addition Remodel

sheet title

Sch Finish Room

phase

revisions

drawing number

GENERAL NOTES

1. GENERAL CONTRACTOR TO SUBMIT SHOP DRAWINGS AND CUTSHEETS PRIOR TO ORDERING OR FABRICATION OF DOORS AND HARDWARE.

2. REFERENCE A5.1 AND A5.2 FOR HEAD JAMB, SILL AND

THRESHOLD DETAILS

3. GENERAL CONTRACTOR TO NOTIFY ARCHITECT OF ANY UNKNOWN CONDITIONS

UNCOVERED UPON DEMOLITION

4. GENERAL CONTRACTOR TO VERIFY DIMENSIONS OF WINDOW AND DOOR ROUGH OPENINGS PRIOR TO FABRICATION AND TO NOTIFY ARCHITECT OF DISCREPANCIES UNCOVERED IN

5. GENERAL CONTRACTOR TO PATCH AND REPAIR AND REFINISH EXISTING SURFACES AROUND NEW DOOR AND WINDOW INSTALLATIONS AS NECESSARY

6. REFERENCE A6.1 ROOM FINISH SCHEDULE FOR FINISH

DETAILS

TEMPERED FROSTED! GLASS

TYPE G TYPE H TYPE I TYPE J

MARK	INTERIOR OR EXTERIOR	WIDTH (ROUGH OPENING)	HEIGHT (ROUGH OPENING)	FRAME SIZE	THICKNESS	OPERATION TYPE	REUSE / REFURBISH / RELOCATE EXISTING DOOR / JAMB	NEW	DOOR TYPE	FRAME MATERIAL	EXTERIOR FINISH	INTERIOR FINISH	GLAZING	THRESHOLD	HARDWARE	MANUFACTURER	REMARKS
D01	EXT.	3'-0 1/2"	7'-9 3/4"	2'-10" x 7'-8"	1 3/4"	SWING		•	А	CLAD PINE, PAINT GRADE	PAINT EXT PAINT 02	PAINT W02	YES, TEMPERED	1/4" BRASS	SET 1	PELLA OR EQUAL	WITH FIXED UPPER TRANSOM DOUBLE PANE LOW-E IG WITH ARGON FILL, DARK BRONZE SPACER
D02	EXT.	3'-0 1/2"	6'-10 3/4"	2'-10" x 6'-9"	1 3/4"	SWING		•	В	CLAD PINE, PAINT GRADE	PAINT EXT PAINT 02	PAINT W02	YES, TEMPERED	1/4" BRASS	SET 2	PELLA OR EQUAL	DOUBLE PANE LOW-E IG WITH ARGON FILL, DARK BRONZE SPACER
D03	EXT.	17'-10 1/2"	8'-0 1/4"	(5) x 3'-8" x 7'-10 3/4"	1 3/4"	SLIDING XOOOX		•	С	CLAD PINE, PAINT GRADE	PAINT EXT PAINT 02	PAINT W02	YES, TEMPERED	TRACK PER MANUFACTURER	SET 3	PELLA OR EQUAL	DOUBLE PANE LOW-E IG WITH ARGON FILL, DARK BRONZE SPACER
D04	EXT.	3'-0 1/2" (Existing V.I.F.)	7'-1 1/2" (Existing V.I.F.)	2'-10" x 7'-0" (Existing V.I.F.)	EXISTING	SWING	•		D	EXISTING	PAINT EXT PAINT 02	PAINT W02	EXISTING	EXISTING	SET 1	-	-
D05	EXT.	EXISTING	EXISTING	EXISTING	EXISTING	GARAGE - OVERHEAD SECTIONAL	•		Е	EXISTING	PAINT EXT PAINT 02	PAINT EXT PAINT 03	-	-	EXISTING	-	REPAIR AND REFININSH
D06	EXT.	EXISTING	EXISTING	EXISTING	EXISTING	GARAGE - OVERHEAD SECTIONAL	•		Е	EXISTING	PAINT EXT PAINT 03	PAINT EXT PAINT 03	-	-	EXISTING	-	REPAIR AND REFININSH
D07	INT.	2'-10 1/2" Existing V.I.F.)	7'-0 1/2" (Existing V.I.F.)	2'-8" x 6'-11"	1 3/8"	SWING	•		F	EXISTING	N/A	PAINT W01	NO	-	SET 4	-	RELOCATED EXISTING INTERIOR DOOR PER PLAN
D08	INT.	2'-10 1/2"	7'-0 1/2"	2'-8" x 6'-11"	1 3/8"	SWING		•	F	SOLID-CORE	N/A	PAINT W01	NO	-	SET 4	CUSTOM	MATCH PANEL STYLE AND DOOR CASING OF EXISTING INTERIOR DOORS
D09	INT.	2'-10 1/2" (Existing V.I.F.)	7'-0 1/2" (Existing V.I.F.)	2'-8" x 6'-11"	1 3/8"	SWING	•		F	EXISTING	N/A	PAINT W01	NO	-	SET 4	-	RELOCATED EXISTING INTERIOR DOOR PER PLAN
D10	INT.	2'-10 1/2" (Existing V.I.F.)	7'-0 1/2" (Existing V.I.F.)	2'-8" x 6'-11"	1 3/8"	SWING	•		F	EXISTING	N/A	PAINT W01	NO	-	SET 4	-	RELOCATED EXISTING INTERIOR DOOR PER PLAN
D11	INT.		,	2'-6" x 6'-11"	1 3/8"	POCKET		•	G	SOLID CORE	N/A	PAINT W01	NO	-	SET 5	CUSTOM	POCKET DOOR TO MATCH PANELING AND TRIM DETAILS OF EXISTING INTERIOR DOORS
D12	INT.	2'-10 1/2"*	7'-0 1/2"*	2'-8" x 6'-11"	1 3/8"	POCKET		•	G	EXISTING	N/A	PAINT W01	NO	-	SET 5	CUSTOM	POCKET DOOR TO MATCH PANELING AND TRIM DETAILS OF EXISTING INTERIOR DOORS
D13	INT.	2'-5 1/2"*	7'-0 1/2"*	2'-3" x 6'-11"	5/8"	POCKET		•	Н	FRAMELESS GLASS	N/A		NO	-	SET 6	-	USE SAME HARDWARE SET AS ON FRAMELESS GLASS SHOWER DOOR
D14	INT.	2'-8 1/2" Existing V.I.F.)	7'-0 1/2" Existing V.I.F.)	2'-6" x 6'-11" (V.I.F.)	1 3/8"	SWING	•		F	EXISTING	N/A	PAINT W01	NO	-	SET 4	-	RELOCATED DOOR PER PLAN
D15	INT.	6'-6 1/2"	7'-0 1/2"	(4) x 1'-7" x 6'-11"	1 3/8"	BIFOLD		•	I	SOLID-CORE	N/A	PAINT W01	NO	-	SET 7	-	BIFOLD DOOR TO MATCH PANELING AND TRIM DETAILS OF EXISTING INTERIOR DOORS
D16	INT.	2'-10 1/2" (Existing V.I.F.)	7'-0 1/2" (Existing V.I.F.)	2'-8" x 6'-11" (V.I.F.)	1 3/8"	SWING	•		F	EXISTING	N/A	PAINT W01	NO	-	SET 4	-	RELOCATED DOOR PER PLAN
D17	INT.	2'-10 1/2"	7'-0 1/2"	2'-8" x 6'-11"	1 3/8"	POCKET		•	G	SOLID-CORE	N/A	PAINT W01	NO	-	SET 5	-	POCKET DOOR TO MATCH PANELING AND TRIM DETAILS OF EXISTING INTERIOR DOORS
D18	INT.	5'-2 1/2"	7'-0 1/2"	(4) x 1'-3" x 6'-11"	1 3/8"	BIFOLD		•	I	SOLID-CORE	N/A	PAINT W01	NO	-	SET 7	-	BIFOLD DOOR TO MATCH PANELING AND TRIM DETAILS OF EXISTING INTERIOR DOORS
D19	INT.	2'-10 1/2"	6'-9 1/2"	2'-8" x 6'-8"	1 3/8"	SWING		•	J	SOLID-CORE	N/A	PAINT W01	NO	-	SET 4	-	RELOCATED DOOR PER PLAN
D20	INT.	2'-8 1/2"	6'-9 1/2"	2'-6" x 6'-8"	1 3/8"	SWING		•	J	SOLID-CORE	N/A	PAINT W01	NO	-	SET 4	-	RELOCATED DOOR PER PLAN
D21	INT.	Existing	Existing	2'-8" x 6'-11" (V.I.F.)	1 3/8"	SWING	•		F	EXISTING	N/A	PAINT W01	NO	-	SET 4	-	EXISTING DOOR TO BE REFURBISHED & REFINISHED
D22	INT.	2'-10 1/2" (V.I.F.)	7'-0 1/2" (V.I.F.)	2'-8" x 6'-11" (Existing V.I.F.)	1 3/8"	SWING	•		F	EXISTING	N/A	PAINT W01	NO	-	SET 4	-	RELOCATED DOOR PER PLAN

- ROUGH OPENING HEIGHT CALCULATED FROM ABOVE FINISH FLOOR

- REFER TO A6.1 FOR FINISHES


* VERIFY NECESSARY ROUGH OPENING HEIGHT AND WIDTH TO ACCOMMODATE POCKET DOOR HARDWARE AND POCKET DEPTH PRIOR TO

** USE SPECIFIED DOOR HARDWARE SETS IF AVAILABLE WITH SELECTED MANUFACTURER'S DOORS. COORDINATE FINAL SELECTION OF DOOR HARDWARE WITH OWNER AND ARCHITECT IF SELECTED DOOR MANUFACTURER CANNOT INSTALL DOOR HARDWARE SETS AS SPECIFIED

USE DOUBLE PANE LOW-E IG WITH ARGON FILL, DARK BRONZE SPACER

1 DOOR SCHEDULE

No Scale

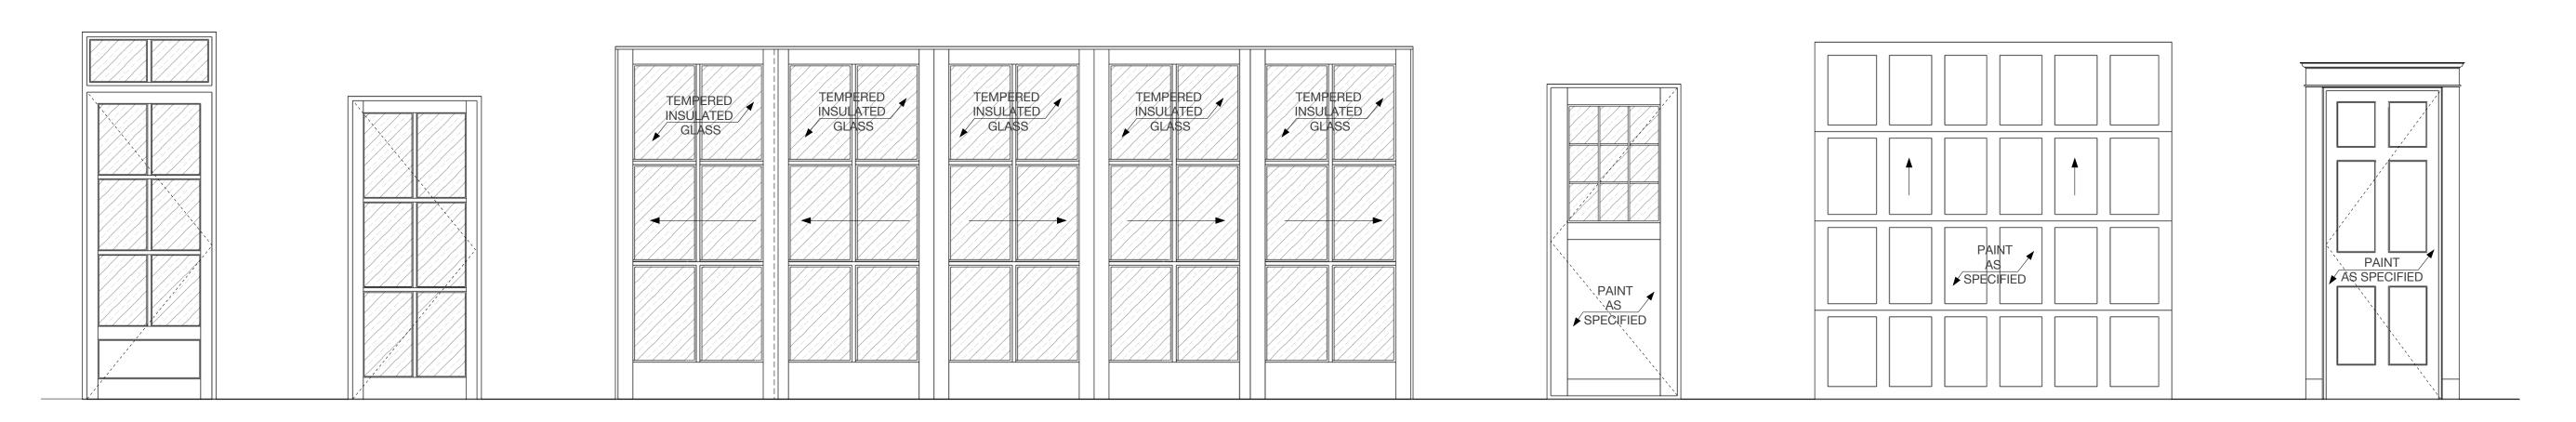

TYPE A TYPE B TYPE C TYPE T

2 DOOR TYPES

Scale: 1/2" = 1'-0"

Not for construction, permitting or regulatory approval

dateNovember 11, 2022

architect



project name

Prado ResidenceRemodel and Addition
227 W. Gramercy Place,

sheet title

Oor and Sash Scheulde

phase CD

rev	isio	ns	

drawing number

A6.2

MARK	WIDTH	HEIGHT	ROUGH OPENING (Width x Height)	OPERATION TYPE	SILL HEIGHT	ТҮРЕ	FRAME MATERIAL	EXTERIOR FINISH	INTERIOR FINISH	MANUFACTURER	DOUBLE PANE LOW-E IG WITH ARGON FILL, DARK BRONZE SPACER	SHUTTERS	REMARKS
W13	3'-0 1/2"	7'-1 1/4"	EXISTING	CASEMENT, OUTSWING	0'-0"	TYPE HH	ALU CLAD	EXT PAINT 02	PAINT W02	PELLA OR EQUAL	YES	-	TOP PORTION OF UNIT TO BE OPERABLE
W14	3'-10 1/2"	7'-6 1/2"	3'-11 1/4" x 7'-7 1/4"	FIXED	0'-5"	TYPE II	ALU CLAD	EXT PAINT 02	PAINT W02	PELLA OR EQUAL	YES	-	-
W15	3'-1 5/8"	7'-6 1/2"	3'-2 3/8 x 7'-7 1/4"	FIXED	0'-0"	TYPE LL	ALU CLAD	EXT PAINT 02	PAINT W02	PELLA OR EQUAL	NO	-	-
W16	3'-1 5/8"	7'-6 1/2"	3'-2 3/8" x 7'-7 1/4"	FIXED	0'-0"	TYPE LL	ALU CLAD	EXT PAINT 02	PAINT W02	PELLA OR EQUAL	NO	-	-
W17	3'-1 5/8"	7'-6 1/2"	3'-2 3/8" x 7'-7 1/4"	FIXED	0'-0"	TYPE LL	ALU CLAD	EXT PAINT 02	PAINT W02	PELLA OR EQUAL	NO	-	-
W18	3'-1 5/8"	7'-6 1/2"	3'-2 3/8" x 7'-7 1/4"	FIXED	0'-0"	TYPE LL	ALU CLAD	EXT PAINT 02	PAINT W02	PELLA OR EQUAL	YES	-	-
W19	3'-1 5/8"	7'-6 1/2"	3'-2 3/8" x 7'-7 1/4"	FIXED	0'-0"	TYPE LL	ALU CLAD	EXT PAINT 02	PAINT W02	PELLA OR EQUAL	YES	-	-
W20	3'-10 1/2"	7'-6 1/2"	3'-11 1/4" × 7'-7 1/4"	FIXED	0'-0"	TYPE LL	ALU CLAD	EXT PAINT 02	PAINT W02	PELLA OR EQUAL	YES	-	
W21	3'-1 5/8"	7'-6 1/2"	3'-2 3/8" x 7'-7 1/4"	FIXED	0'-0"	TYPE LL	ALU CLAD	EXT PAINT 02	PAINT W02	PELLA OR EQUAL	YES	-	-
W22	3'-1 5/8"	7'-6 1/2"	3'-2 3/8" x 7'-7 1/4"	FIXED	0'-0"	TYPE LL	ALU CLAD	EXT PAINT 02	PAINT W02	PELLA OR EQUAL	YES	-	-
W23	3'-1 5/8"	7'-6 1/2"	3'-2 3/8" x 7'-7 1/4"	FIXED	0'-0"	TYPE LL	ALU CLAD	EXT PAINT 02	PAINT W02	PELLA OR EQUAL	YES	-	-
W24	3'-1 5/8"	7'-6 1/2"	3'-2 3/8" x 7'-7 1/4"	FIXED	0'-0"	TYPE LL	ALU CLAD	EXT PAINT 02	PAINT W02	PELLA OR EQUAL	YES	-	-
W25	3'-1 5/8"	7'-6 1/2"	3'-2 3/8" x 7'-7 1/4"	FIXED	0'-0"	TYPE LL	ALU CLAD	EXT PAINT 02	PAINT W02	PELLA OR EQUAL	YES	-	-
W26	V.I.F.	VARIES	V.I.F.	FIXED	0'-0"	TYPE MM	ALU CLAD	EXT PAINT 02	PAINT W02	PELLA OR EQUAL	YES	-	CUSTOM SHAPE WINDOW INTO THE TRIANGULAR GABLE OPENING
W27	V.I.F.	VARIES	V.I.F.	FIXED	0'-0"	TYPE MM	ALU CLAD	EXT PAINT 02	PAINT W02	PELLA OR EQUAL	YES	-	CUSTOM SHAPE WINDOW INTO THE TRIANGULAR GABLE OPENING

ROUGH OPENING HEIGHT CALCULATED FROM ABOVE FINISH FLOOR

REFERENCE A6.1 FOR FINISHES

FOR OPERABLE WINDOWS - INSTALL CRANK-OUT HARDWARE, WEATHERSTRIPPING, HARDWARE, HINGES TO BE DARK BRONZE / OIL RUBBED BRONZE

FOR FIXED WINDOWS - INSTALL HINGES TO BE DARK BRONZE / OIL RUBBED BRONZE

* PROVIDE ALTERNATE PRICING FOR PELLA <u>ARCHITECT SERIES TRADITIONAL PRECISION FIT</u> CASEMENT WINDOWS

3 WINDOW SCHEDULE - STUDIO

No Scale

MARK	WIDTH	НЕІСНТ	ROUGH OPENING (Width x Height)	OPERATION TYPE	SILL HEIGHT	TYPE	FRAME MATERIAL	EXTERIOR FINISH	INTERIOR FINISH	MANUFACTURER	DOUBLE PANE LOW-E IG WITH ARGON FILL, DARK BRONZE SPACER	SHUTTERS	REMARKS
W1	2'-7"	5'-2"	2'-7 3/4" x 5'-2 3/4"	CASEMENT OUTSWING	3'-2"	TYPE AA	ALUMINUM CLAD	EXT PAINT 02	PAINT W02	PELLA OR EQUAL	YES	-	FIXED TRANSOM ABOVE OPERABLE UNIT
W2	2'-7"	5'-2"	2'-7 3/4" x 5'-2 3/4"	FIXED	3'-2"	TYPE AA	ALUMINUM CLAD	EXT PAINT 02	PAINT W02	PELLA OR EQUAL	YES	-	FIXED TRANSOM ABOVE OPERABLE UNIT
W3	8'-3 1/2"	5'-2"	8'-4 1/4" x 5'-2 3/4"	CASEMENT, OUTSWING	3'-2"	TYPE BB	ALUMINUM CLAD	EXT PAINT 02	PAINT W02	PELLA OR EQUAL	YES	-	3 IDENTICAL UNIT MULLED TOGETHER
W4	2'-5 1/2"	4'-5"	2'-10" x 2'-8"	CASEMENT, OUTSWING	2'-5"	TYPE CC	ALUMINUM CLAD	EXT PAINT 02	PAINT W02	PELLA OR EQUAL	YES	-	-
W5	2'-8 1/2"	6'-10"	2'-9 1/4" x 6'-10 3/4"	FIXED	0'-0"	TYPE DD	ALUMINUM CLAD	EXT PAINT 02	PAINT W02	PELLA OR EQUAL	YES	-	
W6	2'-8 1/2"	6'-10"	2'-9 1/4" x 6'-10 3/4"	FIXED	0'-0"	TYPE DD	ALUMINUM CLAD	EXT PAINT 02	PAINT W02	PELLA OR EQUAL	YES	-	
W7	8'-3 1/2"	2'-7 1/2"	8'-4 1/4" x 2'-8 1/4"	FIXED / KICK- OUT	4'-2 1/2"	TYPE EE	ALUMINUM CLAD	EXT PAINT 02	PAINT W02	PELLA OR EQUAL	YES	-	3 IDENTICAL UNIT MULLED TOGETHER
W8	6'-5 3/4"	6'-11 3/4"	6'-6 1/2" x 7'-0 1/2"	FIXED	0'-0"	TYPE FF	MAHOGANY OR CYPRESS	EXT PAINT 02	EXT PAINT 02	CUSTOM	NO	-	SASHES WITH SCREENS - SCREEN TO BE SELECTED BY ARCHITECT
W9	4'-0 1/2"	6'-11 3/4"	4'-1 1/4" x 7'-0 1/2"	FIXED	0'-0"	TYPE GG	MAHOGANY OR CYPRESS	EXT PAINT 02	EXT PAINT 02	CUSTOM	NO	-	SASHES WITH SCREENS - SCREEN TO BE SELECTED BY ARCHITECT
W10	4'-0 1/2"	6'-11 3/4"	4'-1 1/4 x 7'-0 1/2"	FIXED	0'-0"	TYPE GG	MAHOGANY OR CYPRESS	EXT PAINT 02	EXT PAINT 02	CUSTOM	NO	-	SASHES WITH SCREENS - SCREEN TO BE SELECTED BY ARCHITECT
W11	4'-0 1/2"	6'-11 3/4"	4'-1 1/4" x 7'-0 1/2"	FIXED	0'-0"	TYPE GG	MAHOGANY OR CYPRESS	EXT PAINT 02	EXT PAINT 02	CUSTOM	NO	-	SASHES WITH SCREENS - SCREEN TO BE SELECTED BY ARCHITECT
W12	6'-5 3/4"	6'-11 3/4"	6'-6 1/2" x 7'-0 1/2"	FIXED	0'-0"	TYPE FF	MAHOGANY OR CYPRESS	EXT PAINT 02	EXT PAINT 02	CUSTOM	NO	-	SASHES WITH SCREENS - SCREEN TO BE SELECTED BY ARCHITECT

ROUGH OPENING HEIGHT CALCULATED FROM ABOVE FINISH FLOOR

REFERENCE A6.1 FOR FINISHES


FOR OPERABLE WINDOWS - INSTALL CRANK-OUT HARDWARE, WEATHERSTRIPPING, HARDWARE, HINGES TO BE DARK BRONZE / OIL RUBBED BRONZE

FOR FIXED WINDOWS - INSTALL HINGES TO BE DARK BRONZE / OIL RUBBED BRONZE

* PROVIDE ALTERNATE PRICING FOR PELLA <u>ARCHITECT SERIES TRADITIONAL PRECISION FIT</u> CASEMENT WINDOWS

1 WINDOW SCHEDULE - MAIN HOUSE

No Scale

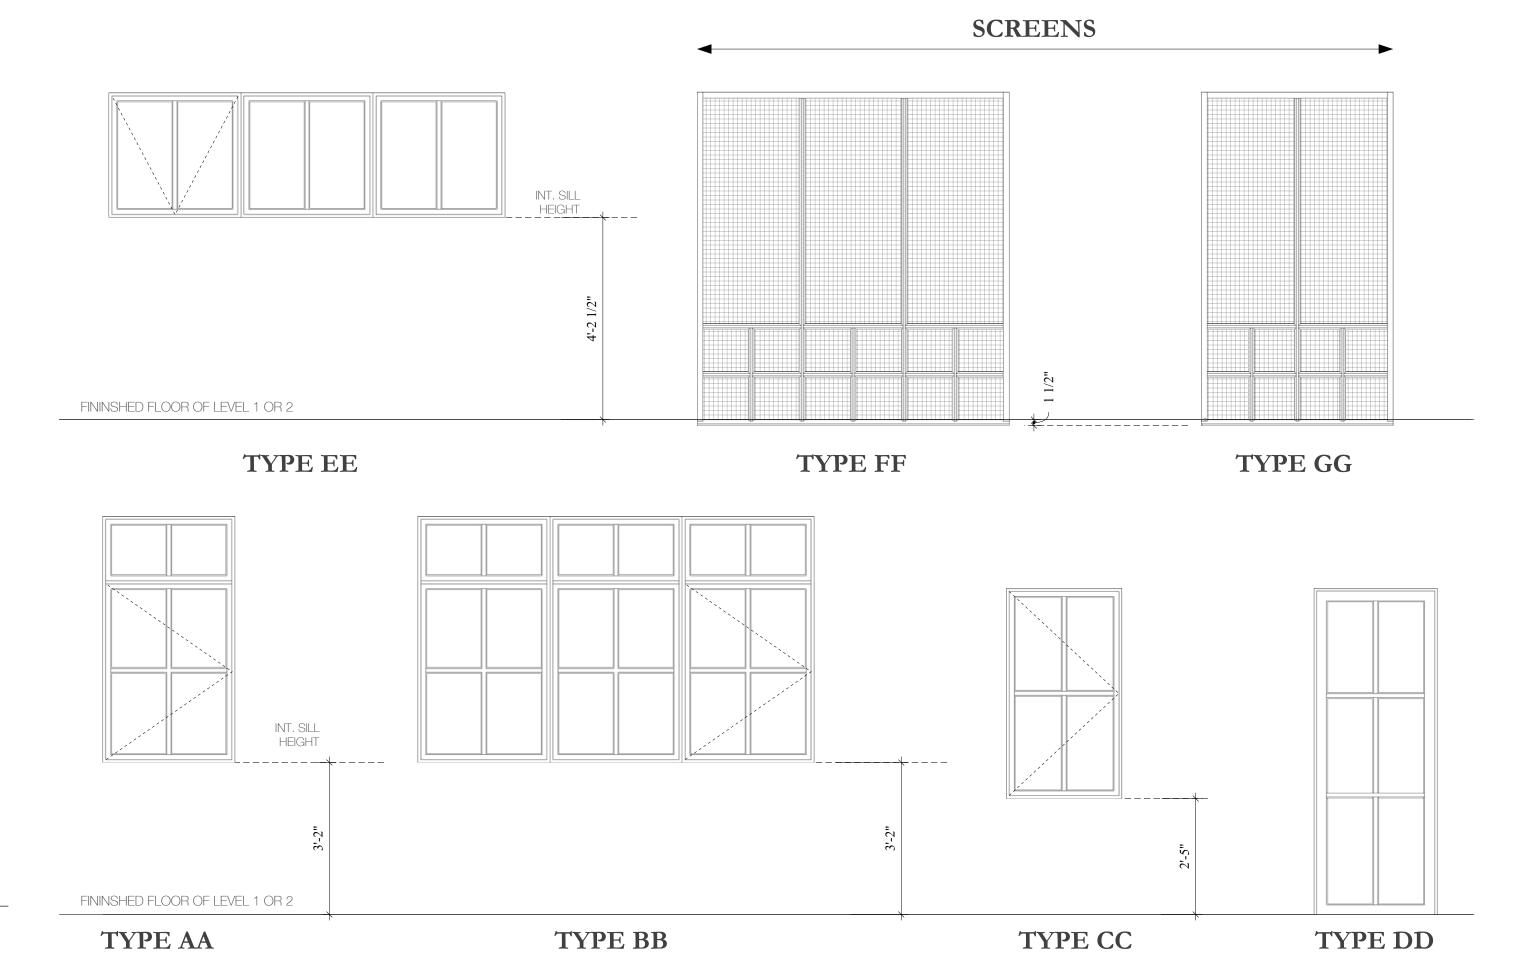

2 WINDOW TYPES - MAIN HOUSE

GENERAL NOTES

1. REFERENCE A5.1 AND A5.2 FOR HEAD JAMB, SILL AND THRESHOLD DETAILS

2. GENERAL CONTRACTOR TO NOTIFY ARCHITECT OF ANY UNKNOWN CONDITIONS UNCOVERED UPON DEMOLITION

3. GENERAL CONTRACTOR TO VERIFY DIMENSIONS OF WINDOW AND DOOR ROUGH OPENINGS PRIOR TO FABRICATION AND TO NOTIFY ARCHITECT OF DISCREPANCIES UNCOVERED IN FIELD

4. GENERAL CONTRACTOR TO
PATCH AND REPAIR AND REFINISH
EXISTING SURFACES AROUND NEW
DOOR AND WINDOW INSTALLATIONS AS
NECESSARY

5. REFERENCE A6.1 ROOM FINISH SCHEDULE FOR FINISH DETAILS

Not for construction,

construction, permitting or regulatory approval

dateNovember 11, 2022

Péli And Mason Architecture Shop
1149 E. Commerce St, Suite 200

San Antonio, TX 78205

project name

Prado Residence
Remodel and Addition
227 W. Gramercy Place,
San Antonio, TX 78212

sheet title

Window Schadule

phase CD

revisions

drawing number

A6.3

11/11/2022

Scale 1/2"=1'-0"

2 WINDOW TYPES - MAIN HOUSE

TYPE HH


TYPE II

TYPE LL


FININSHED FLOOR OF LEVEL 1 OR 2

TYPE MM

LIGHTING FIXTURE SCHEDULE - STUDIO

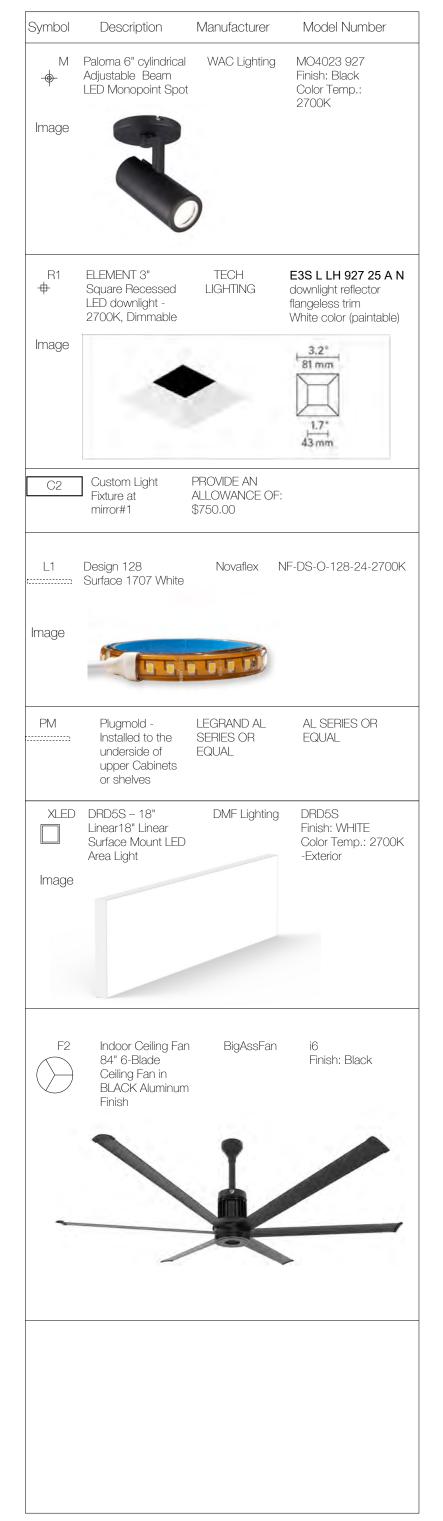

LIGHTING FIXTURE SCHEDULE - MAIN RESIDENCE

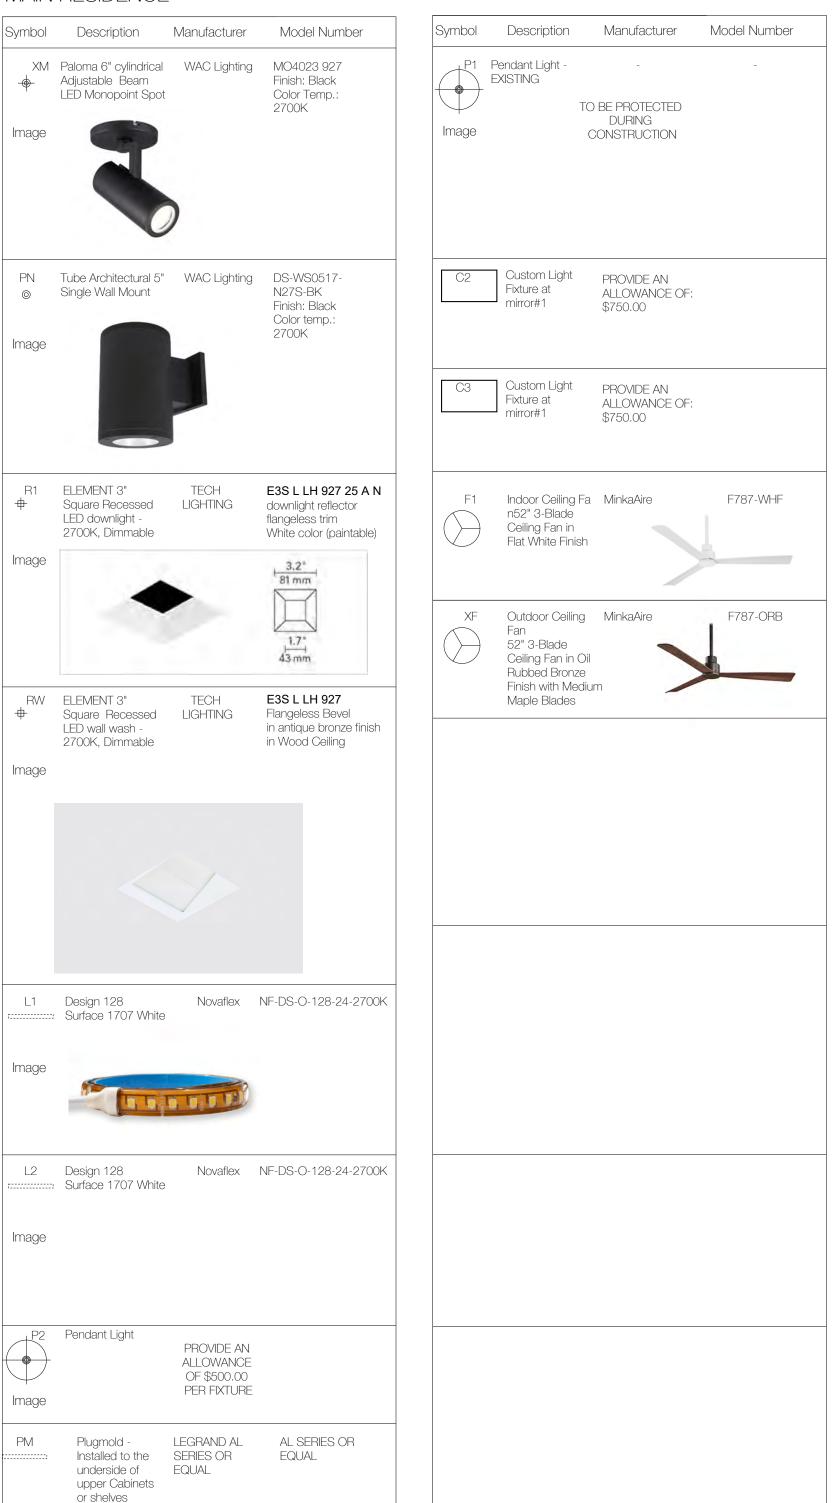

GENERAL NOTES

- 1. GENERAL CONTRACTOR TO SUBMIT PRODUCT CUTSHEETS TO OWNER AND ARCHITECT FOR FINAL APPROVAL.
- 2. REFER TO REFLECTED CEILING PLAN (A1.3) AND INTERIOR ELEVATIONS FOR LOCATIONS OF LIGHT FIXTURES, OUTLETS, SWITCHES, AND FANS
- 3. GENERAL CONTRACTOR TO PROVIDE ELECTRICAL INFRASTRUCTURE, WIRING, AND GROUNDING TO COMPLY WITH ALL CODES AND STANDARDS REQUIRED BY THE CITY OF SAN ANTONIO.
- 4. SEE FLOOR PLANS AND INTERIOR ELEVATIONS FOR PLUMBING FIXTURE LOCATIONS IN RELATION TO ADJACENT BUILDING COMPONENTS.
- 5. GENERAL CONTRACTOR TO PROVIDE PLUMBING INFRASTRUCTURE AND TO COMPLY WITH CODES AND STANDARDS REQUIRED BY THE CITY OF SAN ANTONIO
- 6. SEE INTERIOR ELEVATIONS FOR LOCATION OF APPLIANCES, COVER PANELS, AND HANDLE LOCATIONS
- 7. GENERAL CONTRACTOR TO PROVIDE PLUMBING AND ELECTRICAL INFRASTRUCTURE AS REQUIRED PER APPLIANCE MANUFACTURERS' INSTRUCTIONS
- 8. BATH ACCESSORIES TO BE PROVIDED BY OWNER AND INSTALLED BY CONTRACTOR

Not for construction, permitting or

dateNovember 11, 2022

regulatory approval

Péli And Mason Architecture Shop
1149 E. Commerce St, Suite 200
San Antonio, TX 78205

project name

Prado Residence
Remodel and Addition
227 W. Gramercy Place,

sheet title

Project Schedules -Lighting Fixtures

phase CD

revisions

drawing number

A6.4

APPLIANCE SCHEDULE - MAIN HOUSE

APPLIANCE SCHEDULE - STUDIO



PLUMBING FIXTURE SCHEDULE -MAIN HOUSE

Symbol	Description	Manufacturer	Model Number
P1	Kitchen Sink Elkay Quartz Classic 33" Undermount Single Basin Quartz Composite Sink Quartz - White	Elkay	ELGRU13322WH0C
P2	Kitchen Faucet Hansgrohe Talis S ² 1.75 GPM Pull- Down Kitchen Faucet HighArc Spout Finish: Polished Chrome	Hansgrohe	14877001
P3	Bar Sink - Elkay Quartz Classic 15-3/4" x 15- 3/4" x 7- 11/16", Single Bowl Dual Mount Bar Sink	ELKAY	ELG1616BK0
P4	Bar Faucet Elkay Avado 1.8 GPM Single Hole Pull Down Bar Faucet - Includes Escutcheon	Elkay	LKAV3032MB
P5	Master Bath & Bath 02 Sink 19-13/16" Rectangular Undermount Sink with Vertical Sides and Overflow Finish: White	KOHLER	K-2882-0
P6	Master Bath Faucet Metris S 1.2 GPM Single Hole Bathroom Faucet with EcoRight, Quick Clean Finish: Polished Chrome	E.	31020001
P7	Master Bath Tub Hibiscus 67 x 29- 1/2 in. Freestanding Soaker Bathtub with Center Drain in Finish: White, Material: Acrylic	Signature Hardware	e 447006
P8	Master Bath Tub Filler Simoni freestanding tub faucet and shower Finish: Polished Chrome	Signature Hardware	910185
P9	Master Shower Kit Raindance S Thermostatic Showerhead/Wallba r Set with Rough, 2.5 GPM Finish: Polished Chrome	Hansgrohe	4915000
P10	Master Shower Drain Signature Hardware 4" Thornton Square Shower Drain Finish: Polished Chrome	Signature Hardware	9 406470
P11	Toilet Fixture Drake II Two Piece Elongated 1.28 GPF Toilet with CeFiONtect and Tornado Flush Technology Finish: White	Toto	CST454CEFG#01

PLUMBING FIXTURE SCHEDULE -MAIN HOUSE

Description Bath 02 Shower Kit Hansgrohe Croma Thermostatic Bhowerpipe 150 1- Jet with Tub Filler, 2.0 GPM Finish: Polished Chrome	Manufacturer Hansgrohe	Model Number 27143001	Symbol P15	Description Studio Sink - Quartz Classic 24-5/8" Undermount Single Basin Quartz Composite	Manufacturer ELKAY	Model Numl
Hansgrohe Croma Thermostatic Showerpipe 150 1- Jet with Tub Filler, 2.0 GPM Finish: Polished	Hansgrohe	27143001	P15	Quartz Classic 24-5/8" Undermount Single Basin Quartz Composite	ELKAY	ELGU2522Wi
			P2	Kitchen Sink Bar Faucet Hansgrohe Talis S ² 1.75 GPM Pull-	Hansgrohe	LKAV3032CR
Bath 02 Tub Sitka 60" Three Wall	Signature Hardware	÷ 447039		Down Kitchen Faucet HighArc Spout Finish: Polished Chrome	1	
Alcove Acrylic Soaking Tub with Pre-Drilled Overflow Hole	P		P5	Studio Bath Sink 19-13/16" Rectangular Undermount Bathroom Sink with Vertical Sides and Overflow Finish: White	Kohler	K-2882-0
Bath 02 Sink 19-13/16" Rectangular Undermount Bathroom Sink with Vertical Sides and Overflow Finish: White	Kohler	K-2882-0 31060001	P14	Studio Bath Faucet Metris S 1.2 GPM Single Hole Bathroom Faucet with EcoRight, Quick Clean, and ComfortZone Technologies - Drain Assembly	Hansgrohe	31060001
Single Hole Bathroom Faucet with EcoRight, Quick Clean, and ComfortZone Technologies - Drain Assembly Included Finish: Polished Chrome			P15	Finish: Polished Chrome Studio Bath Shower Kit Hansgrohe Croma Thermostatic Showerpipe 220 1-Jet, 2.5 GPM Finish: Polished Chrome	Hansgrohe	27185001
			P10	Laundry Drain Cover Master Shower Drain Signature Hardware 4" Thornton Square Shower Drain Finish: Polished Chrome	Signature Hardwar	re 406470
			P11	Toilet Fixture Drake II Two Piece Elongated 1.28 GPF Toilet with CeFiONtect and Tornado Flush Technology Finish: White	Toto	CST454CEF0
	Alcove Acrylic Soaking Tub with Pre-Drilled Overflow Hole Bath 02 Sink 9-13/16" Rectangular Undermount Bathroom Sink with Vertical Sides and Overflow Finish: White Bath 02 Faucet Metris S 1.2 GPM Single Hole Bathroom Faucet with EcoRight, Quick Clean, and ComfortZone Fechnologies - Orain Assembly Included Finish: Polished	Alcove Acrylic Soaking Tub with Pre-Drilled Overflow Hole Bath 02 Sink 9-13/16" Rectangular Undermount Bathroom Sink vith Vertical Sides and Overflow Finish: White Bath 02 Faucet Metris S 1.2 GPM Single Hole Bathroom Faucet vith EcoRight, Quick Clean, and ComfortZone Technologies - Orain Assembly Included Finish: Polished	Alcove Acrylic Soaking Tub with Pre-Drilled Overflow Hole Bath 02 Sink 9-13/16" Rectangular Undermount Bathroom Sink with Vertical Sides and Overflow Finish: White Bath 02 Faucet Metris S 1.2 GPM Single Hole Bathroom Faucet with EcoRight, Quick Clean, and ComfortZone Technologies - Orain Assembly Included Finish: Polished	Nacove Acrylic Soaking Tub with Pre-Drilled Overflow Hole Bath 02 Sink 9-13/16" Rectangular Indermount Sathroom Sink with Vertical Sides and Overflow Finish: White Bath 02 Faucet Aletris S 1.2 GPM Single Hole Sathroom Faucet with EcoRight, Duick Clean, and ComfortZone Fechnologies - Orain Assembly Included Tinish: Polished Chrome P10 P10	Acova Acylic Society Tub with the Drilled Overflow total P5 Studio Bath Sink 19:13/16" Rectangular Undermount Bathroom Sink with Vertical Sides and Overflow Finish: White Bathroom Sink with Vertical Sides and Overflow Indian White Bathroom Sink with Vertical Sides and Overflow Indian Structure Bathroom Sink with Vertical Sides and Overflow Indian Structure Bathroom Faucet with EcoRight, Ouick Clean, and Comfort/Zone Rectangular Activities Since Paucet with EcoRight, Duick Clean, and Comfort/Zone Rectangular Activities Since Paucet with EcoRight, Duick Clean, and Comfort/Zone Rectangular Bathroom Faucet with EcoRight, Duick Clean, and Comfort/Zone Rectangular Bathroom Faucet with EcoRight, Duick Clean, and Comfort/Zone Rectangular Bathroom Faucet With EcoRight, Duick Clean, and Comfort/Zone Rectangular Bathroom Faucet With EcoRight, Duick Clean, and Comfort/Zone Rectangular Bathroom Faucet With EcoRight, Duick Clean, and Comfort/Zone Rectangular Bathroom Faucet With EcoRight, Duick Clean, and Comfort/Zone Rectangular Bathroom Faucet With EcoRight, Duick Clean, and Comfort/Zone Rectangular Bathroom Faucet With EcoRight, Duick Clean, and Comfort/Zone Rectangular Bathroom Faucet With EcoRight, Duick Clean, and Comfort/Zone Rectangular Bathroom Faucet With EcoRight, Duick Clean, and Comfort/Zone Rectangular Bathroom Faucet With EcoRight, Duick Clean, and Comfort/Zone Rectangular Bathroom Faucet With EcoRight, Duick Clean, and Comfort/Zone Rectangular Bathroom Faucet With EcoRight, Duick Clean, and Comfort/Zone Rectangular Bathroom Faucet With EcoRight, Duick Clean, and Comfort/Zone Rectangular Bathroom Faucet With EcoRight With Pacet Bathroom Faucet Bath	Accove Anyloc coaching 120 with the Drilled Overflow folds of the Part of the

PLUMBING FIXTURE SCHEDULE -





GENERAL NOTES

- 1. GENERAL CONTRACTOR TO SUBMIT PRODUCT CUTSHEETS TO OWNER AND ARCHITECT FOR FINAL APPROVAL.
- 2. REFER TO REFLECTED CEILING PLAN (A1.3) AND INTERIOR ELEVATIONS FOR LOCATIONS OF LIGHT FIXTURES, OUTLETS, SWITCHES, AND FANS
- 3. GENERAL CONTRACTOR TO PROVIDE ELECTRICAL INFRASTRUCTURE, WIRING, AND GROUNDING TO COMPLY WITH ALL CODES AND STANDARDS REQUIRED BY THE CITY OF SAN ANTONIO.
- 4. SEE FLOOR PLANS AND INTERIOR ELEVATIONS FOR PLUMBING FIXTURE LOCATIONS IN RELATION TO ADJACENT BUILDING COMPONENTS.
- 5. GENERAL CONTRACTOR TO PROVIDE PLUMBING INFRASTRUCTURE AND TO COMPLY WITH CODES AND STANDARDS REQUIRED BY THE CITY OF SAN ANTONIO
- 6. SEE INTERIOR ELEVATIONS FOR LOCATION OF APPLIANCES, COVER PANELS, AND HANDLE LOCATIONS
- 7. GENERAL CONTRACTOR TO PROVIDE PLUMBING AND ELECTRICAL INFRASTRUCTURE AS REQUIRED PER APPLIANCE MANUFACTURERS' INSTRUCTIONS
- 8. BATH ACCESSORIES TO BE PROVIDED BY OWNERAND INSTALLED BY CONTRACTOR

Not for construction. permitting or regulatory approval

dateNovember 11, 2022 architect



project name

Residence I and Addition 227 W. Gramercy F. San Antonio, TX 7 Prado l Remodel

sheet title

bing Schedules Appliances, Plum Fixtures Project


phase

revisions

drawing number

11/11/2022

Titanium

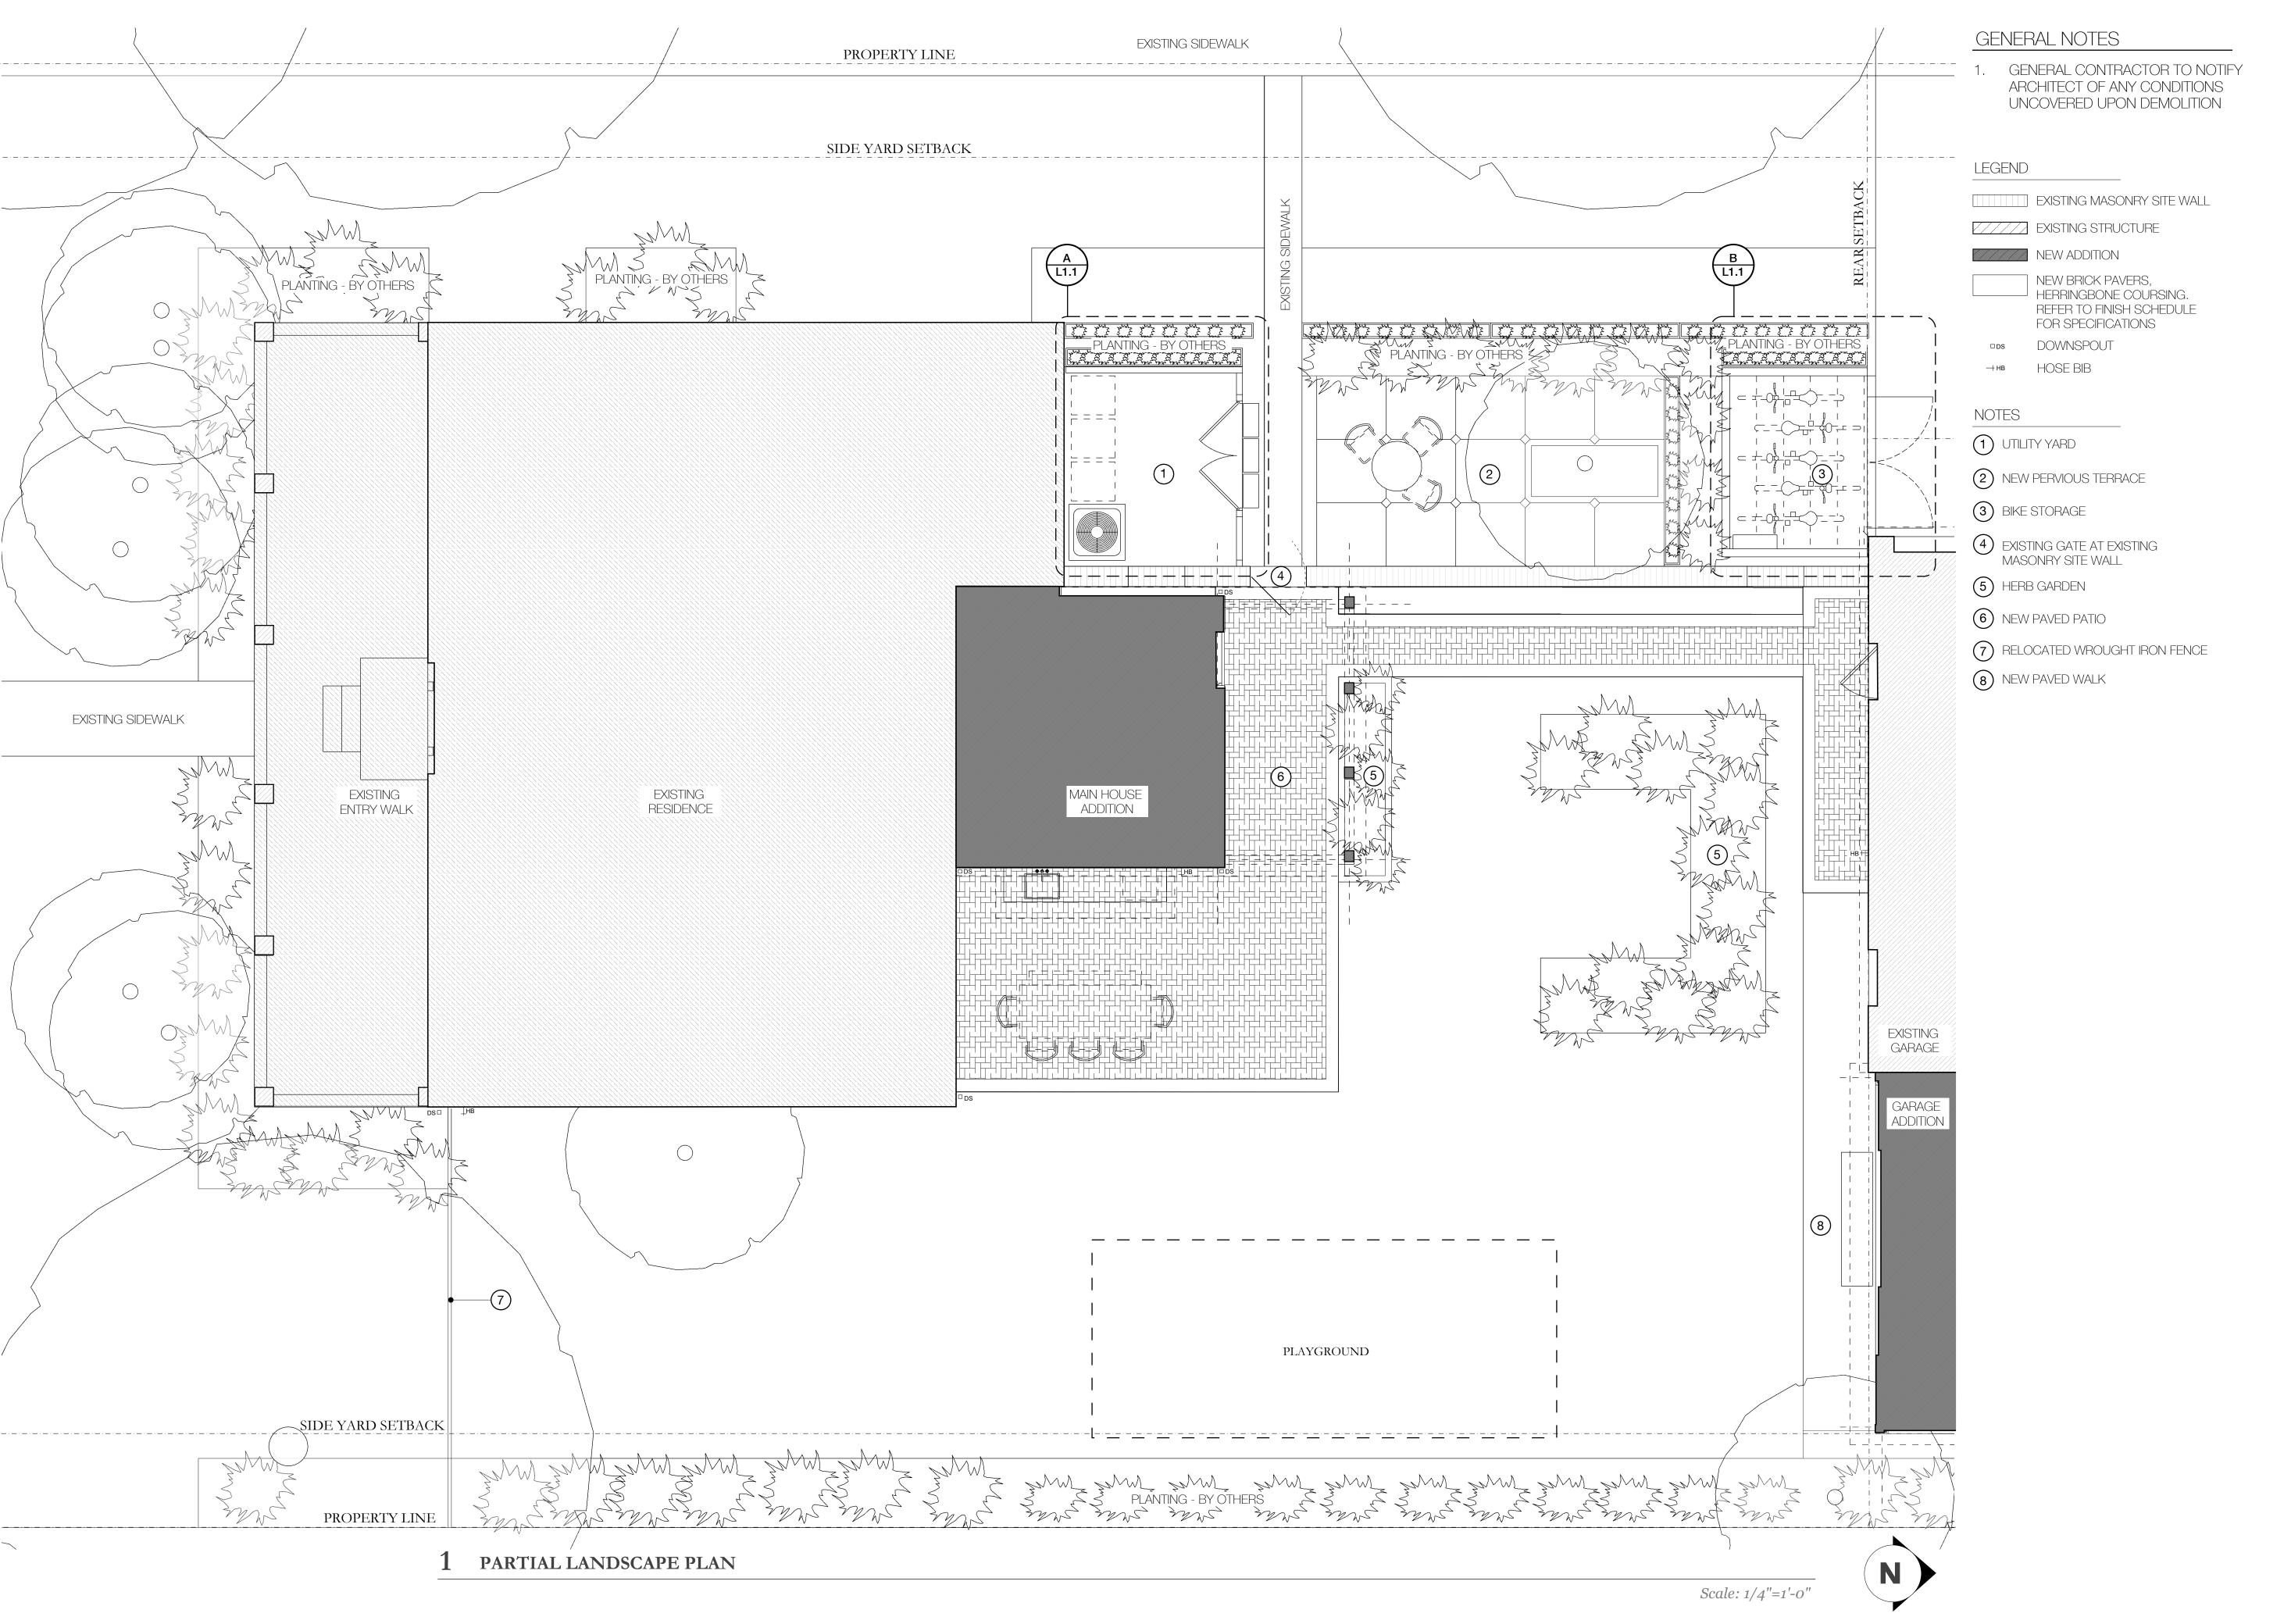

Not for construction, permitting or regulatory approval

date: November 27, 2022

architect



project name

Prado | Remodel

sheet title

revisions

drawing number

11/27/2022

